This plan is strictly protected by copyright laws.
Only the original purchaser of this plan is authorized to use this construction drawing. This plan cannot be sold, distributed, or transferred to any other person. Violators may be prosecuted. ATTIC VENTILATOR For more information: SEE MANUFACTURER) DECORATIVE **Drummond House Plans 1.800.567.5267** - 34" X 14" GABLE VENT **CEDAR SHINGLES** OR IMITATION TOP PLATE 3" DECORATIVE **ASPHALT SHINGLES** 5" X 7" X 3" DECORATIVE BRACKETS SECOND FLOOR TOP PLATE GARAGE 2" DECORATIVE 6" DECORATIVE 5" DECORATIVE SIDING 6" DECORATIVE TRIM TYP. TOP OF FOUNDATION FINISH GRADE PROVIDE SLOPING GRADE AWAY FROM THE BUILDING. **FRONT ELEVATION** MIN. 6" WITHIN THE FIRST 10'-0" ATTIC VENTILATOR
(SYMBOLIC DRAWING, FOR FOUNDATION INFORMATION REFER TO THE "FOUNDATION PLAN" PAGES DECORATIVE AND "TYPICAL WALL SECTION" 34" X 14" GABLE VENT 6" DECORATIVE 2" DECORATIVE 5" DECORATIVE - FLASHING TYP. **ASPHALT SHINGLES** SIDING-_6" DECORATIVE ____ FINISH GRADE PROVIDE SLOPING GRADE AWAY FROM THE BUILDING. **REAR ELEVATION** MIN. 6" WITHIN THE FIRST 10'-0" AREA SCHEDULE DRUMMOND HOUSE PLANS

info@drummondhouseplans.com

1-800-567-5267



NOTES:

THESE PLANS HAVE BEEN DRAWN ACCORDING TO HIGH QUALITY STANDARDS AND PRACTICES AND ARE AN ACCURATE GUIDE TO BUILDING CONSTRUCTION. HOWEVER, LOCAL REGULATIONS AND LOCAL BUILDING CODE REQUIREMENTS VARY, AND AS SUCH, MAY REQUIRE CHANGES. THE BUILDING CONTRACTOR MUST REVISE AND ENSURE WITH HIS CLIENT THAT THE PLANS CONFORM TO ALL CURRENT GOVERNMENTAL AND/OR BUILDING CODE REQUIREMENTS IN THE MUNICIPALITY WHERE THE HOME WILL BE BUILT. THE CLIENT IS RESPONSIBLE FOR THE VERIFICATION OF MUNICIPAL REGULATIONS. DRUMMOND DESIGNS INC, WILL NOT ASSUME LIABILITY FOR MISHAPS BEFORE, DURING, OR AFTER THE USE OF THESE PLANS FOR CONSTRUCTION.


THIS GARAGE PLAN HAS BEEN ORIGINALLY DRAWN BY DRUMMOND DESIGNS INC. AND IS ITS EXCLUSIVE PROPERTY. ANY REPRODUCTION IS STRICTLY FORBIDDEN. THE PURCHASE OF A GARAGE PLAN DOES NOT INCLUDE THE LICENSE FOR ADVERTISING USE; THIS LICENSE CAN BE PURCHASE UPON REQUEST. THE PURCHASE OF A LICENSE IS REQUIRED IF MORE THAN ONE GARAGE IS TO BE BUILT WITH THIS GARAGE PLAN.

YOUR CITY OR STATE MAY REQUIRE THAT YOU HAVE A CERTIFIED ARCHITECT OR ENGINEER APPROVE YOUR PLANS AND AFFIX HIS SEAL TO THE PLANS FOR SAFETY REASONS OR PARTICULAR REGULATIONS.



BRYAN NORWALT (603)365-6061

REVISION NO DATE BY

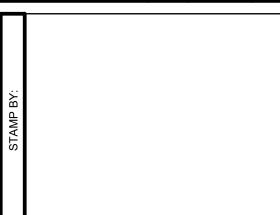

NEW CONSTRUCTION

DRAWIN

All Rights Res

COM

DRUMMOND HOUSEPLANS.

SQ.FT.

446

784


OTHER

GARAGE

BONUS ROOM

ELEVATIONS

DESIGNED E	3Y	DRAWN BY		CHECKED BY	
	D.C.	A.F	RO.	M.S.	
DATE	00/00/2021		SCALE 1/4"=1'-0"		
PLAN NO.		2989-28	SHEET	NO. 1-7	

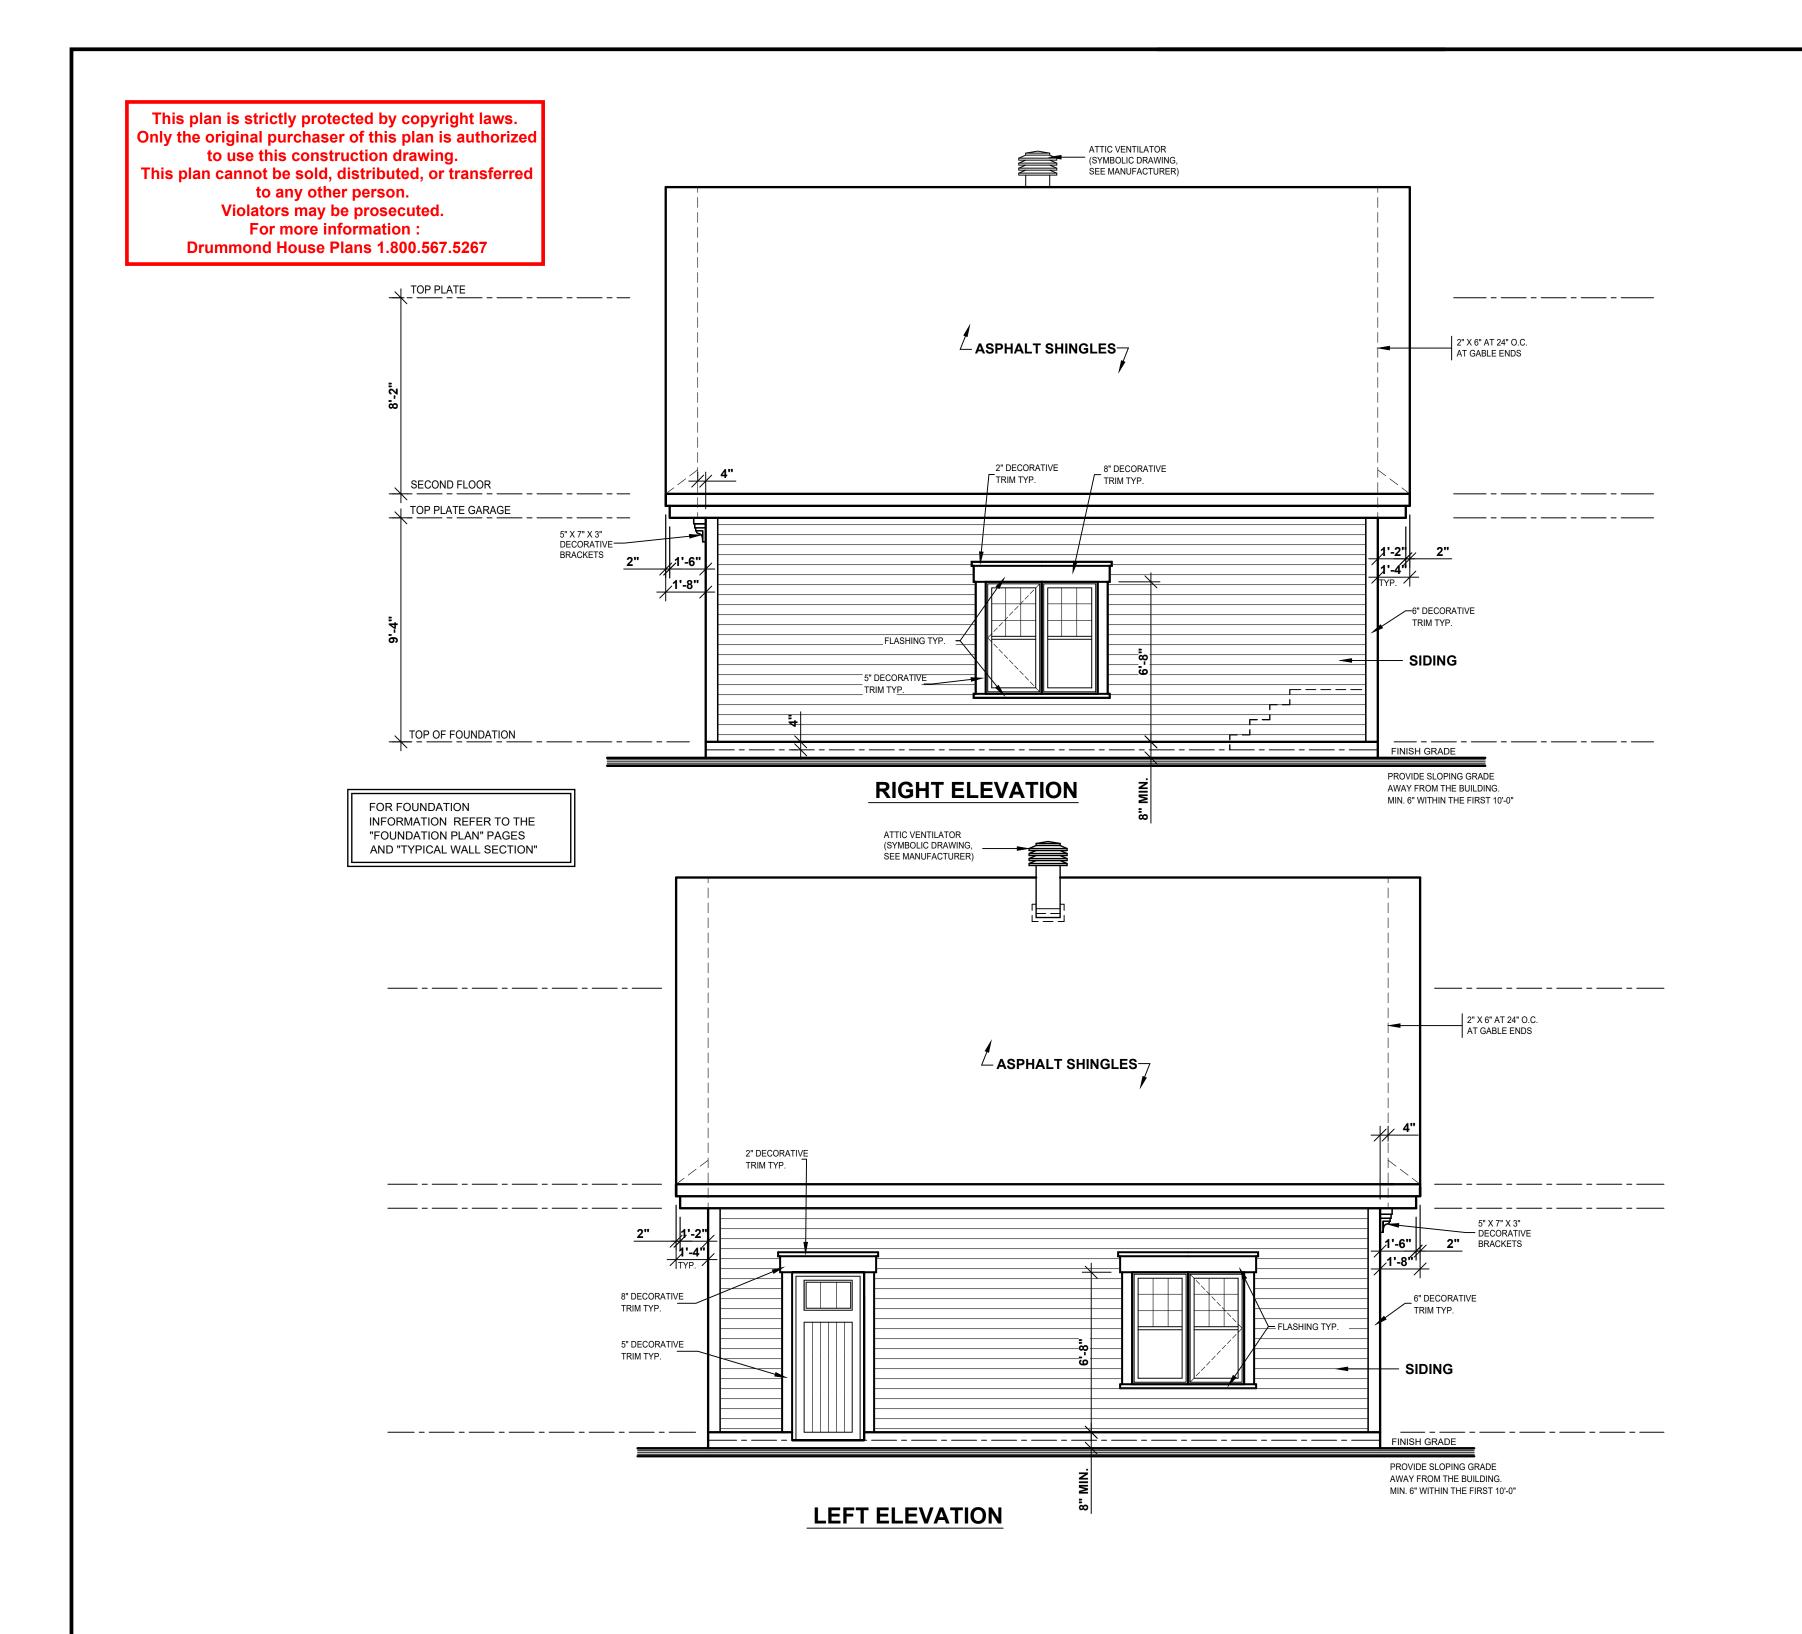

DRUMMOND HOUSE PLANS

info@drummondhouseplans.com

1-800-567-5267



NOTES:

THESE PLANS HAVE BEEN DRAWN ACCORDING TO HIGH QUALITY STANDARDS AND PRACTICES AND ARE AN ACCURATE GUIDE TO BUILDING CONSTRUCTION. HOWEVER, LOCAL REGULATIONS AND LOCAL BUILDING CODE REQUIREMENTS VARY, AND AS SUCH, MAY REQUIRE CHANGES. THE BUILDING CONTRACTOR MUST REVISE AND ENSURE WITH HIS CLIENT THAT THE PLANS CONFORM TO ALL CURRENT GOVERNMENTAL AND/OR BUILDING CODE REQUIREMENTS IN THE MUNICIPALITY WHERE THE HOME WILL BE BUILT. THE CLIENT IS RESPONSIBLE FOR THE VERIFICATION OF MUNICIPAL REGULATIONS. DRUMMOND DESIGNS INC, WILL NOT ASSUME LIABILITY FOR MISHAPS BEFORE, DURING, OR AFTER THE USE OF THESE PLANS FOR CONSTRUCTION.

THIS GARAGE PLAN HAS BEEN ORIGINALLY DRAWN BY DRUMMOND DESIGNS INC. AND IS ITS EXCLUSIVE PROPERTY. ANY REPRODUCTION IS STRICTLY FORBIDDEN. THE PURCHASE OF A GARAGE PLAN DOES NOT INCLUDE THE LICENSE FOR ADVERTISING USE; THIS LICENSE CAN BE PURCHASE UPON REQUEST. THE PURCHASE OF A LICENSE IS REQUIRED IF MORE THAN ONE GARAGE IS TO BE BUILT WITH THIS GARAGE PLAN.

YOUR CITY OR STATE MAY REQUIRE THAT YOU HAVE A CERTIFIED ARCHITECT OR ENGINEER APPROVE YOUR PLANS AND AFFIX HIS SEAL TO THE PLANS FOR SAFETY REASONS OR PARTICULAR REGULATIONS.



BRYAN NORWALT (603)365-6061

RE	VISION	NO	DATE	BY
$\overline{\sqcap}$				
BY:				
STAMP BY:				
S				

NEW CONSTRUCTION

DRAWING

DRUMMOND HOUSEPLANS.COM

ELEVATIONS

DESIGNED I	3Y	DRAWN BY		CHECKED BY
	D.C.	A.F	RO.	M.S.
DATE	00	0/00/2021	SCALE	1/4"=1'-0"
PLAN NO.		2989-28	SHEET	NO. 2-7

- BUILDING CONTRACTOR MUST:

1) VERIFY ALL DIMENSIONS BEFORE PROCEEDING. 2) RESPECT REQUIREMENTS OF DOCUMENTATION ATTACHED TO PLANS AND INFORM THE CLIENT OF ANY CONSEQUENCES RESULTING FROM CHANGES TO PLAN IF APPLICABLE.

- THE DIMENSIONS ON THE PLAN HAVE PRIORITY ON THE DRAWING. CERTAIN DIMENSIONS MAY VARY ACCORDING TO THE MATERIAL USED AND/ OR THE CONTRACTOR'S BUILDING METHODS. IF VARIATIONS EXIST BETWEEN THE BUILDING SITE AND PLANS. THE CONTRACTOR MUST ADVISE DRUMMOND HOUSE PLANS INC. AS SOON AS POSSIBLE.

IMPORTANT NOTES:

-THE CONCRETE USED MUST BE PRODUCED AND DELIVERED BY A FACTORY THAT HAS CERTIFICATE OF CONFORMITY.

-AN APPLICATION OF WOOD PRESERVATIVE IS REQUIRED AT THE EXTREMITIES OF THE BEAMS OR ELEMENTS SUPPORTED ON MASONRY

- ALL EXTERIOR COATINGS MUST BE INSTALLED AS PER MANUFACTURER SPECIFICATIONS.

- MINIMUM FOUNDATION DEPTH BELOW FINISHED GRADE IS 4'-6", THIS DEPTH MAY VARY ACCORDING TO LOCAL CODE REQUIREMENTS.

- ENDS OF STEEL BEAMS SUPPORTED ON EXTERIOR WALL MUST BE INSULATED ON A MINIMUM LENGTH OF 24".

- TO PROTECT AGAINST FROST HEAVE ON ALL CONCRETE FOUNDATIONS WALLS, PILASTER AND CONCRETE ANGLES, MUST BE COVERED WITH EITHER A PROTECTIVE MEMBRANE, 15 LBS ASPHALT PAPER, POLYETHYLENE, RIGID INSULATION OR 1/2" TAR FIBERBOARD.

- 2" MINIMUM SPACE IS REQUIRED BETWEEN THE ROOF AREA AND MOISTURE SENSITIVE EXTERIOR FACING.

-IT IS MANDATORY TO VENTILATE THE ROOF ADEQUATELY. THE VENTILATORS CHOSEN BY THE CUSTOMER AND/OR THE CONTRACTOR WILL BE REQUIRED TO RESPECT THE CURRENT BUILDING CODE.

- THE WINDOW DIMENSIONS IN THIS PLAN MAY VARY DEPENDING ON THE CHOSEN MANUFACTURER. THE WINDOWS MUST COMPLY WITH THE NORTH AMERICAN STANDARD (AAMA / WDMA / CSA). CATEGORY R IS THE MINIMUM CLASSIFICATION LEVEL ACCEPTED.

- ALL VAPOR BARRIERS INDICATED IN THIS PLAN SHOULD BE SEALED WHEN THEY OVERLAP AND AROUND OPENINGS. IT IS IMPORTANT TO INSTALL A VAPOR BARRIER AT THE BACK OF THE ELECTRIC BOXES AND THE SEAL IT.

STRUCTURAL NOTES:

- FRAMING LUMBER (BEAMS, LINTELS, JOISTS) TO BE GRADE NO 1 $\&\,2$ SPRUCE UNLESS OTHERWISE INDICATED.

- ALL LINTELS TO BE 2-2"X10" UNLESS OTHERWISE SPECIFIED.

- ALL POSTS IN EXTERIOR WALL TO BE MIN. 3-2"X6" UNLESS

- ALL INTERIOR POSTS TO BE MIN. 3-2"X4" UNLESS OTHERWISE

-THE TRUSS AND THE PREFABRICATED JOIST MANUFACTURER MUST VERIFY THAT ALL DIMENSIONS ARE IN COMPLIANCE WITH THE PLAN. FOLLOWING THE MANUFACTURER'S CALCULATIONS, SOME DIMENSIONS MAY REQUIRE CERTAIN ADJUSTMENTS. THE MANUFACTURER WILL BE FULLY RESPONSIBLE OF TRUSS AND FLOOR DESIGN AND WILL MAKE SURE THEY MEET THE ENGINEERING STANDARDS AND REGULATIONS.

- TEMPORARY AND PERMANENT TRUSS BRACING MUST BE INSTALLED AS PER TRUSS MANUFACTURER AND CODE REGULATIONS.

- THE PLYWOOD PANELS MAY BE REPLACED BY AN ORIENTED STRESS BOARD PANEL (OSB) OR EQUIVALENT.

- PROVIDE BRACING IN ALL EXTERIOR WALL CORNERS. BRACING CAN BE MADE OF 1/2" PLYWOOD, 1/2" OSB OR STEEL BRACING INSTALLED

- IN A MASONRY WALL, THE HORIZONTAL STEEL CLAMPS ARE TO BE PLACED AT A MAX. 3'-0" SPACING, THE VERTICAL ONES AT 16" MAX. THE SIZE OF THE STEEL LINTELS (OVER OPENINGS) TO BE DETERMINED BY THE MACON.

Only the original purchaser of this plan is authorized to use this construction drawing. This plan cannot be sold, distributed, or transferred to any other person. Violators may be prosecuted. For more information:

Drummond House Plans 1.800.567.5267

GARAGE DOOR

-4" MIN. CONCRETE SLAB (32 MPA MIN.)

-2" RIGID INSULATION TYPE 4 (R-10) 2'-0" MIN. -6" OF 3/4" DB CRUSHED STONE

IT IS RECOMMENDED TO CONSULT AN ENGINEER CONCERNING -THE FOUNDATION FRAMEWORK

AND REINFORCEMENT

-.006" POLYETHYLENE

UNDISTURBED

(AS PER MANUFACTURER)—

-x-x-x-x-x-x-x-x-x-x-x-x-x-x-x-

INSULATION


2'-0" MIN. UNDER

FINISHED GROUND LEVEL

SECTION

NO SCALE

This plan is strictly protected by copyright laws.

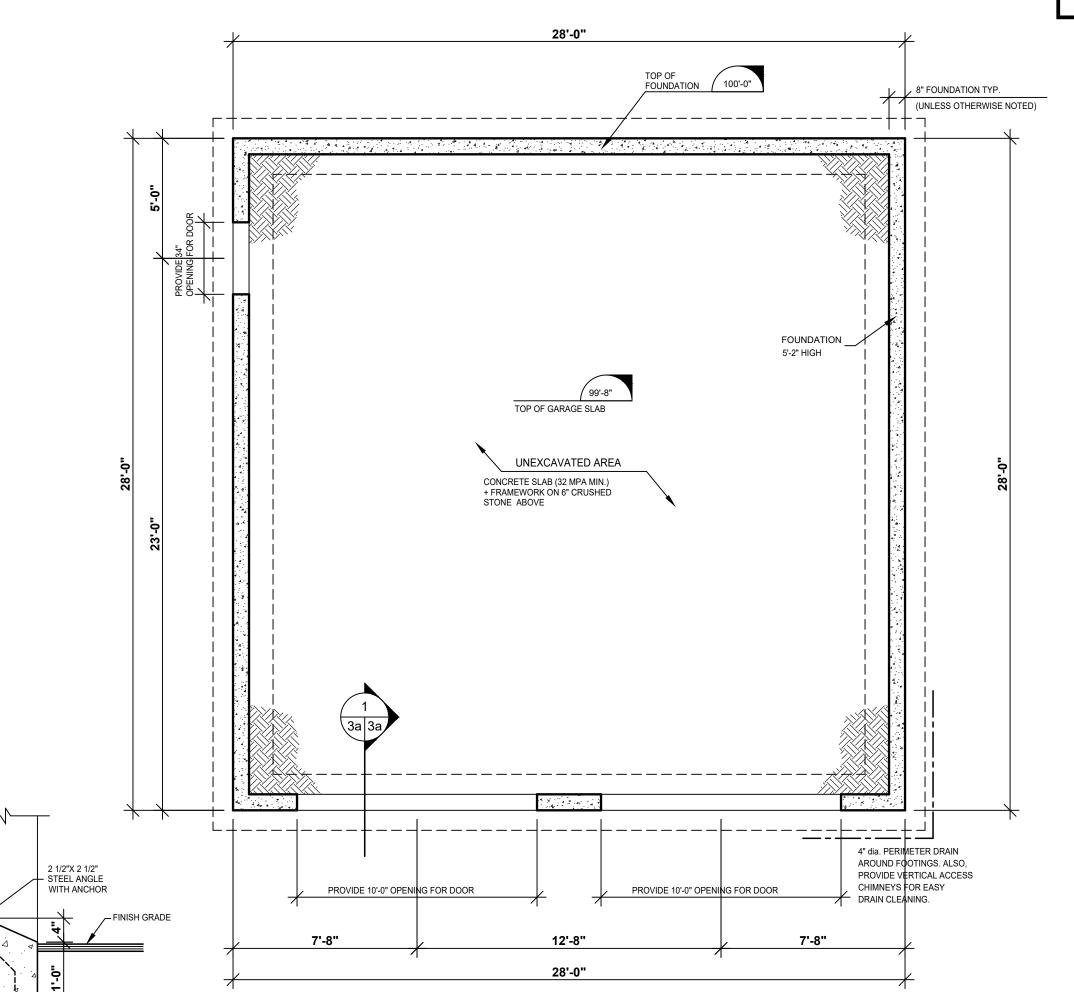

FLOATING SLAB FOUNDATION

DRUMMOND HOUSE PLANS

info@drummondhouseplans.com

1-800-567-5267



NOTES:

THESE PLANS HAVE BEEN DRAWN ACCORDING TO HIGH QUALITY STANDARDS AND PRACTICES AND ARE AN ACCURATE GUIDE TO BUILDING CONSTRUCTION HOWEVER, LOCAL REGULATIONS AND LOCAL BUILDING CODE REQUIREMENTS VARY, AND AS SUCH, MAY REQUIRE CHANGES. THE BUILDING CONTRACTOR MUS REVISE AND ENSURE WITH HIS CLIENT THAT THE PLANS CONFORM TO ALL CURRENT GOVERNMENTAL AND/OR BUILDING CODE REQUIREMENTS IN THE MUNICIPALITY WHERE THE HOME WILL BE BUILT. THE CLIENT IS RESPONSIBLE FOR THE VERIFICATION OF MUNICIPAL REGULATIONS. DRUMMOND DESIGNS INC, WILL NOT ASSUME LIABILITY FOR MISHAPS BEFORE, DURING, OR AFTER THE USE OF THESE PLANS FOR CONSTRUCTION.

THIS GARAGE PLAN HAS BEEN ORIGINALLY DRAWN BY DRUMMOND DESIGNS INC AND IS ITS EXCLUSIVE PROPERTY. ANY REPRODUCTION IS STRICTLY FORBIDDEN THE PURCHASE OF A GARAGE PLAN DOES NOT INCLUDE THE LICENSE FOR ADVERTISING USE; THIS LICENSE CAN BE PURCHASE UPON REQUEST. THE PURCHASE OF A LICENSE IS REQUIRED IF MORE THAN ONE GARAGE IS TO BE BUILT WITH THIS GARAGE PLAN.

YOUR CITY OR STATE MAY REQUIRE THAT YOU HAVE A CERTIFIED ARCHITECT



BRYAN NORWALT (603)365-6061

RE\	VISION	NO	DATE	BY
		-		
STAMP BY:				

All Rights

COM


HOUSEPLANS

DRUMMOND

NEW CONSTRUCTION

FOUNDATIONS PLAN (FLOATING SLAB)

D20:0:12D D:		DIVAVINDI		OFFICIALD DI	
	D.C.	A.F	RO.		M.S.
DATE	00	0/00/2021	SCALE		1/4"=1'-0"
PLAN NO.		2989-28	SHEET	NO.	3a-7

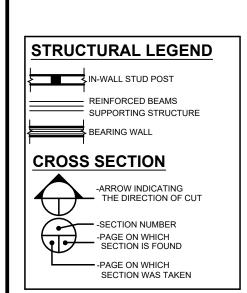

- BUILDING CONTRACTOR MUST:

1) VERIFY ALL DIMENSIONS BEFORE PROCEEDING. 2) RESPECT REQUIREMENTS OF DOCUMENTATION ATTACHED TO PLANS AND INFORM THE CLIENT OF ANY CONSEQUENCES RESULTING FROM CHANGES TO PLAN IF APPLICABLE.

- THE DIMENSIONS ON THE PLAN HAVE PRIORITY ON THE DRAWING. CERTAIN DIMENSIONS MAY VARY ACCORDING TO THE MATERIAL USED AND/ OR THE CONTRACTOR'S BUILDING METHODS. IF VARIATIONS EXIST BETWEEN THE BUILDING SITE AND PLANS. THE CONTRACTOR MUST ADVISE DRUMMOND HOUSE PLANS INC. AS SOON AS POSSIBLE.

-THE CONCRETE USED MUST BE PRODUCED AND DELIVERED BY A FACTORY THAT HAS CERTIFICATE OF CONFORMITY.

-AN APPLICATION OF WOOD PRESERVATIVE IS REQUIRED AT THE EXTREMITIES OF THE BEAMS OR ELEMENTS SUPPORTED ON MASONRY

- ALL EXTERIOR COATINGS MUST BE INSTALLED AS PER MANUFACTURER SPECIFICATIONS.

- MINIMUM FOUNDATION DEPTH BELOW FINISHED GRADE IS 4'-6", THIS DEPTH MAY VARY ACCORDING TO LOCAL CODE REQUIREMENTS.

- ENDS OF STEEL BEAMS SUPPORTED ON EXTERIOR WALL MUST BE INSULATED ON A MINIMUM LENGTH OF 24".

- TO PROTECT AGAINST FROST HEAVE ON ALL CONCRETE FOUNDATIONS WALLS, PILASTER AND CONCRETE ANGLES, MUST BE COVERED WITH EITHER A PROTECTIVE MEMBRANE, 15 LBS ASPHALT PAPER, POLYETHYLENE, RIGID INSULATION OR 1/2" TAR FIBERBOARD.

- 2" MINIMUM SPACE IS REQUIRED BETWEEN THE ROOF AREA AND MOISTURE SENSITIVE EXTERIOR FACING.

-IT IS MANDATORY TO VENTILATE THE ROOF ADEQUATELY. THE VENTILATORS CHOSEN BY THE CUSTOMER AND/OR THE CONTRACTOR WILL BE REQUIRED TO RESPECT THE CURRENT BUILDING CODE.

THE WINDOW DIMENSIONS IN THIS PLAN MAY VARY DEPENDING ON THE CHOSEN MANUFACTURER. THE WINDOWS MUST COMPLY WITH THE NORTH AMERICAN STANDARD (AAMA / WDMA / CSA). CATEGORY R IS THE MINIMUM CLASSIFICATION LEVEL ACCEPTED.

- ALL VAPOR BARRIERS INDICATED IN THIS PLAN SHOULD BE SEALED WHEN THEY OVERLAP AND AROUND OPENINGS. IT IS IMPORTANT TO INSTALL A VAPOR BARRIER AT THE BACK OF THE ELECTRIC BOXES

STRUCTURAL NOTES:

- FRAMING LUMBER (BEAMS, LINTELS, JOISTS) TO BE GRADE NO 1 & 2 SPRUCE UNLESS OTHERWISE INDICATED.

- ALL LINTELS TO BE 2-2"X10" UNLESS OTHERWISE SPECIFIED.

- ALL POSTS IN EXTERIOR WALL TO BE MIN. 3-2"X6" UNLESS OTHERWISE SPECIFIED.

- ALL INTERIOR POSTS TO BE MIN. 3-2"X4" UNLESS OTHERWISE

-THE TRUSS AND THE PREFABRICATED JOIST MANUFACTURER MUST VERIFY THAT ALL DIMENSIONS ARE IN COMPLIANCE WITH THE PLAN. FOLLOWING THE MANUFACTURER'S CALCULATIONS, SOME DIMENSIONS MAY REQUIRE CERTAIN ADJUSTMENTS. THE MANUFACTURER WILL BE FULLY RESPONSIBLE OF TRUSS AND FLOOR DESIGN AND WILL MAKE SURE THEY MEET THE ENGINEERING STANDARDS AND REGULATIONS.

- TEMPORARY AND PERMANENT TRUSS BRACING MUST BE INSTALLED AS PER TRUSS MANUFACTURER AND CODE REGULATIONS.

- THE PLYWOOD PANELS MAY BE REPLACED BY AN ORIENTED STRESS BOARD PANEL (OSB) OR EQUIVALENT.

PROVIDE BRACING IN ALL EXTERIOR WALL CORNERS. BRACING CAN BE MADE OF 1/2" PLYWOOD, 1/2" OSB OR STEEL BRACING INSTALLED

- IN A MASONRY WALL, THE HORIZONTAL STEEL CLAMPS ARE TO BE PLACED AT A MAX. 3'-0" SPACING, THE VERTICAL ONES AT 16" MAX. THE SIZE OF THE STEEL LINTELS (OVER OPENINGS) TO BE DETERMINED BY THE MACON.

This plan is strictly protected by copyright laws. Only the original purchaser of this plan is authorized to use this construction drawing. This plan cannot be sold, distributed, or transferred to any other person.

Violators may be prosecuted. For more information: **Drummond House Plans 1.800.567.5267**


GARAGE DOOR

ANTICIPATE STEEL REINFORCEMENT IN FOOTINGS AND CONCRETE SLAB

RECOMMENDATIONS OF AN P-ENG,

WHERE REQUIRED WITH THE

(AS PER MANUFACTURER)-

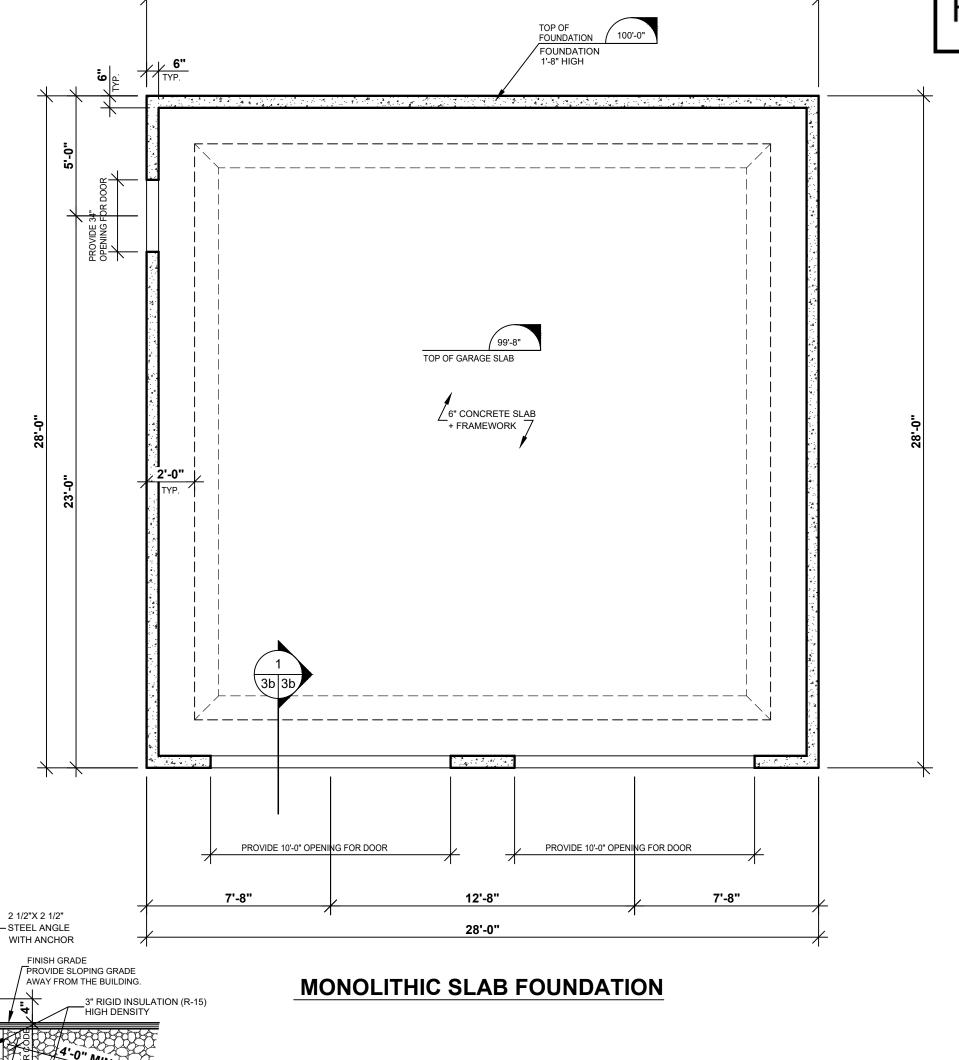

28'-0"

DRUMMOND HOUSE PLANS

info@drummondhouseplans.com

1-800-567-5267

DRUMMOND HOUSE PLANS

NOTES:

AND PRACTICES AND ARE AN ACCURATE GUIDE TO BUILDING CONSTRUCTION. HOWEVER, LOCAL REGULATIONS AND LOCAL BUILDING CODE REQUIREMENTS VARY, AND AS SUCH, MAY REQUIRE CHANGES. THE BUILDING CONTRACTOR MUS' REVISE AND ENSURE WITH HIS CLIENT THAT THE PLANS CONFORM TO ALL CURRENT GOVERNMENTAL AND/OR BUILDING CODE REQUIREMENTS IN THE MUNICIPALITY WHERE THE HOME WILL BE BUILT. THE CLIENT IS RESPONSIBLE FOR THE VERIFICATION OF MUNICIPAL REGULATIONS. DRUMMOND DESIGNS INC, WILL NOT ASSUME LIABILITY FOR MISHAPS BEFORE, DURING, OR AFTER THE USE OF THESE PLANS FOR CONSTRUCTION.

THESE PLANS HAVE BEEN DRAWN ACCORDING TO HIGH QUALITY STANDARDS

THIS GARAGE PLAN HAS BEEN ORIGINALLY DRAWN BY DRUMMOND DESIGNS INC. AND IS ITS EXCLUSIVE PROPERTY. ANY REPRODUCTION IS STRICTLY FORBIDDEN. THE PURCHASE OF A GARAGE PLAN DOES NOT INCLUDE THE LICENSE FOR ADVERTISING USE; THIS LICENSE CAN BE PURCHASE UPON REQUEST. THE PURCHASE OF A LICENSE IS REQUIRED IF MORE THAN ONE GARAGE IS TO BE BUILT WITH THIS GARAGE PLAN.

YOUR CITY OR STATE MAY REQUIRE THAT YOU HAVE A CERTIFIED ARCHITECT OR ENGINEER APPROVE YOUR PLANS AND AFFIX HIS SEAL TO THE PLANS FOR SAFETY REASONS OR PARTICULAR REGULATIONS.



BRYAN NORWALT (603)365-6061

REVISION NO DATE BY

All Rights

COM


HOUSEPLANS

DRUMMOND

NEW CONSTRUCTION

FOUNDATIONS PLAN (MONOLITHIC SLAB)

M.S. D.C. A.RO. SCALE 00/00/2021 1/4"=1'-0" 2989-28 3b-7

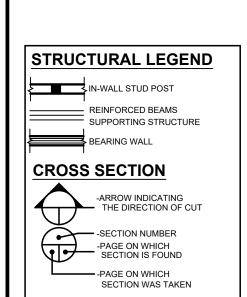

- BUILDING CONTRACTOR MUST:

VERIFY ALL DIMENSIONS BEFORE PROCEEDING.
 RESPECT REQUIREMENTS OF DOCUMENTATION ATTACHED TO PLANS AND INFORM THE CLIENT OF ANY CONSEQUENCES RESULTING FROM CHANGES TO PLAN IF APPLICABLE.

- THE DIMENSIONS ON THE PLAN HAVE PRIORITY ON THE DRAWING. CERTAIN DIMENSIONS MAY VARY ACCORDING TO THE MATERIAL USED AND/OR THE CONTRACTOR'S BUILDING METHODS. IF VARIATIONS EXIST BETWEEN THE BUILDING SITE AND PLANS, THE CONTRACTOR MUST ADVISE DRUMMOND HOUSE PLANS INC. AS SOON AS POSSIBLE.

IMPORTANT NOTES:

-THE CONCRETE USED MUST BE PRODUCED AND DELIVERED BY A FACTORY THAT HAS CERTIFICATE OF CONFORMITY.

-AN APPLICATION OF WOOD PRESERVATIVE IS REQUIRED AT THE EXTREMITIES OF THE BEAMS OR ELEMENTS SUPPORTED ON MASONRY

- ALL EXTERIOR COATINGS MUST BE INSTALLED AS PER MANUFACTURER SPECIFICATIONS.

- MINIMUM FOUNDATION DEPTH BELOW FINISHED GRADE IS 4'-6", THIS DEPTH MAY VARY ACCORDING TO LOCAL CODE REQUIREMENTS.

- ENDS OF STEEL BEAMS SUPPORTED ON EXTERIOR WALL MUST BE INSULATED ON A MINIMUM LENGTH OF 24".

- TO PROTECT AGAINST FROST HEAVE ON ALL CONCRETE FOUNDATIONS WALLS, PILASTER AND CONCRETE ANGLES, MUST BE COVERED WITH EITHER A PROTECTIVE MEMBRANE, 15 LBS ASPHALT PAPER, POLYETHYLENE, RIGID INSULATION OR 1/2" TAR FIBERBOARD.

- 2" MINIMUM SPACE IS REQUIRED BETWEEN THE ROOF AREA AND MOISTURE SENSITIVE EXTERIOR FACING.

-IT IS MANDATORY TO VENTILATE THE ROOF ADEQUATELY. THE VENTILATORS CHOSEN BY THE CUSTOMER AND/OR THE CONTRACTOR WILL BE REQUIRED TO RESPECT THE CURRENT BUILDING CODE.

- THE WINDOW DIMENSIONS IN THIS PLAN MAY VARY DEPENDING ON THE CHOSEN MANUFACTURER. THE WINDOWS MUST COMPLY WITH THE NORTH AMERICAN STANDARD (AAMA / WDMA / CSA). CATEGORY R IS THE MINIMUM CLASSIFICATION LEVEL ACCEPTED.

- ALL VAPOR BARRIERS INDICATED IN THIS PLAN SHOULD BE SEALED WHEN THEY OVERLAP AND AROUND OPENINGS. IT IS IMPORTANT TO INSTALL A VAPOR BARRIER AT THE BACK OF THE ELECTRIC BOXES AND THE SEAL IT.

STRUCTURAL NOTES:

- FRAMING LUMBER (BEAMS, LINTELS, JOISTS) TO BE GRADE NO 1 & 2 SPRINCE LINESS OTHERWISE INDICATED.

- ALL LINTELS TO BE 2-2"X10" UNLESS OTHERWISE SPECIFIED.

- ALL POSTS IN EXTERIOR WALL TO BE MIN. 3-2"X6" UNLESS

- ALL INTERIOR POSTS TO BE MIN. 3-2"X4" UNLESS OTHERWISE

-THE TRUSS AND THE PREFABRICATED JOIST MANUFACTURER MUST VERIFY THAT ALL DIMENSIONS ARE IN COMPLIANCE WITH THE PLAN. FOLLOWING THE MANUFACTURER'S CALCULATIONS, SOME DIMENSIONS MAY REQUIRE CERTAIN ADJUSTMENTS. THE MANUFACTURER WILL BE FULLY RESPONSIBLE OF TRUSS AND FLOOR DESIGN AND WILL MAKE SURE THEY MEET THE ENGINEERING STANDARDS AND REGULATIONS.


- TEMPORARY AND PERMANENT TRUSS BRACING MUST BE INSTALLED AS PER TRUSS MANUFACTURER AND CODE REGULATIONS.

- THE PLYWOOD PANELS MAY BE REPLACED BY AN ORIENTED STRESS BOARD PANEL (OSB) OR EQUIVALENT.

- PROVIDE BRACING IN ALL EXTERIOR WALL CORNERS. BRACING CAN BE MADE OF 1/2" PLYWOOD, 1/2" OSB OR STEEL BRACING INSTALLED AT 46° AND LE

- IN A MASONRY WALL, THE HORIZONTAL STEEL CLAMPS ARE TO BE PLACED AT A MAX. 3'-0" SPACING, THE VERTICAL ONES AT 16" MAX. THE SIZE OF THE STEEL LINTELS (OVER OPENINGS) TO BE DETERMINED BY THE MACON.

This plan is strictly protected by copyright laws.
Only the original purchaser of this plan is authorized to use this construction drawing.
This plan cannot be sold, distributed, or transferred to any other person.
Violators may be prosecuted.
For more information:
Drummond House Plans 1.800.567.5267

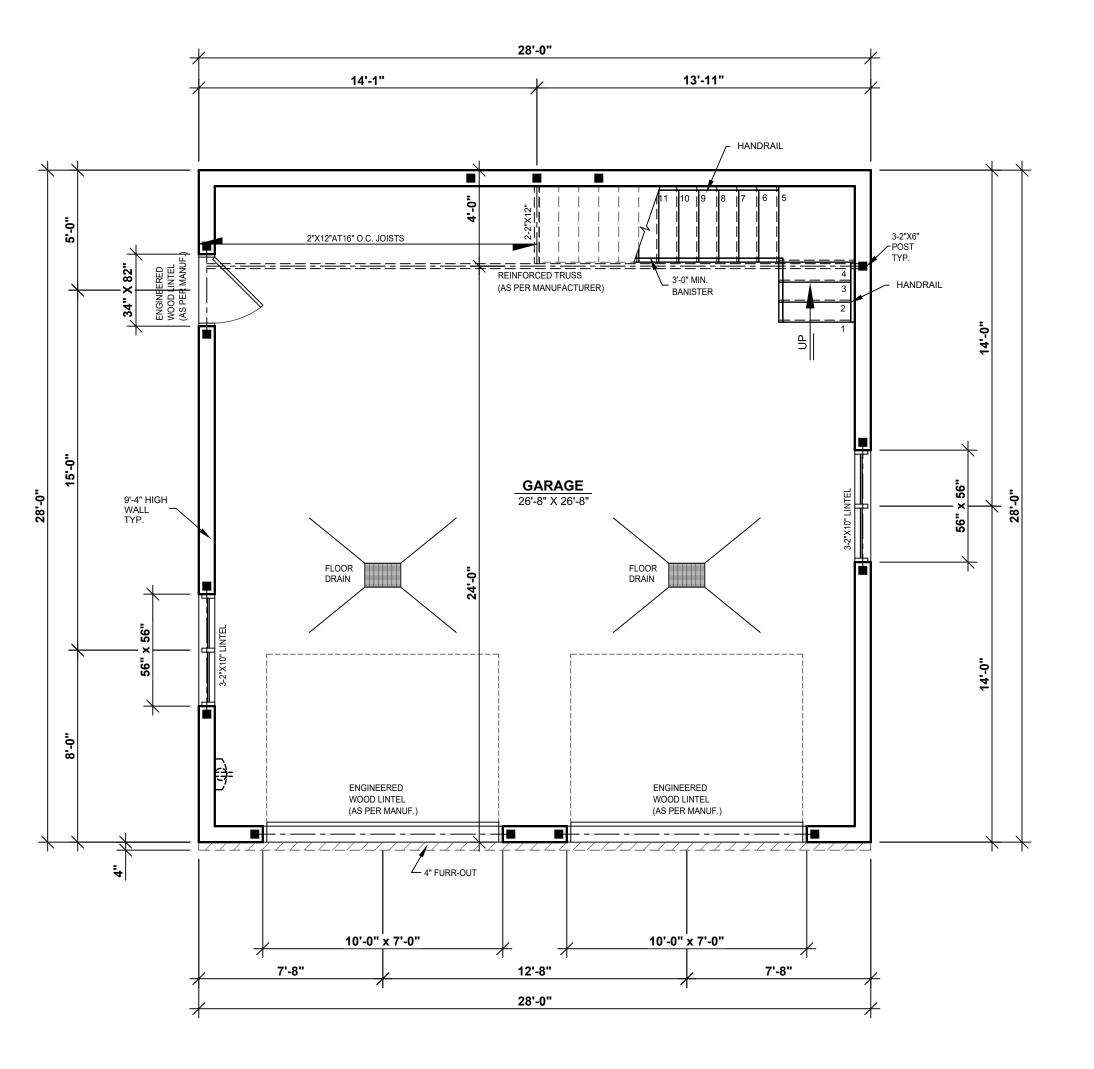

DRUMMOND HOUSE PLANS

info@drummondhouseplans.com

1-800-567-5267



NOTES:

THESE PLANS HAVE BEEN DRAWN ACCORDING TO HIGH QUALITY STANDARDS AND PRACTICES AND ARE AN ACCURATE GUIDE TO BUILDING CONSTRUCTION. HOWEVER, LOCAL REGULATIONS AND LOCAL BUILDING CODE REQUIREMENTS VARY, AND AS SUCH, MAY REQUIRE CHANGES. THE BUILDING CONTRACTOR MUST REVISE AND ENSURE WITH HIS CLIENT THAT THE PLANS CONFORM TO ALL CURRENT GOVERNMENTAL AND/OR BUILDING CODE REQUIREMENTS IN THE MUNICIPALITY WHERE THE HOME WILL BE BUILT. THE CLIENT IS RESPONSIBLE FOR THE VERIFICATION OF MUNICIPAL REGULATIONS. DRUMMOND DESIGNS INC, WILL NOT ASSUME LIABILITY FOR MISHAPS BEFORE, DURING, OR AFTER THE USE OF THESE PLANS FOR CONSTRUCTION.

THIS GARAGE PLAN HAS BEEN ORIGINALLY DRAWN BY DRUMMOND DESIGNS INC. AND IS ITS EXCLUSIVE PROPERTY. ANY REPRODUCTION IS STRICTLY FORBIDDEN. THE PURCHASE OF A GARAGE PLAN DOES NOT INCLUDE THE LICENSE FOR ADVERTISING USE; THIS LICENSE CAN BE PURCHASE UPON REQUEST. THE PURCHASE OF A LICENSE IS REQUIRED IF MORE THAN ONE GARAGE IS TO BE BUILT WITH THIS GARAGE PLAN.

YOUR CITY OR STATE MAY REQUIRE THAT YOU HAVE A CERTIFIED ARCHITECT OR ENGINEER APPROVE YOUR PLANS AND AFFIX HIS SEAL TO THE PLANS FOR SAFETY REASONS OR PARTICULAR REGULATIONS.



BRYAN NORWALT (603)365-6061

RE\	VISION	NO	DATE	BY
STAMP BY:				

NEW CONSTRUCTION

DRAWING

All Rights

COM


HOUSEPLANS

DRUMMOND

GROUND FLOOR PLAN

DRAWN BY

	D.C.	A.F	₹0.		M.S.
DATE	00	0/00/2021	SCALE		1/4"=1'-0"
PLAN NO.		2989-28	SHEET	NO.	4-7

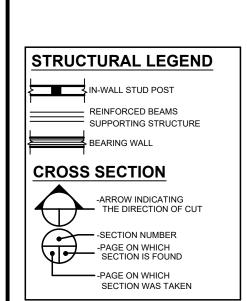

- BUILDING CONTRACTOR MUST:

VERIFY ALL DIMENSIONS BEFORE PROCEEDING.
 RESPECT REQUIREMENTS OF DOCUMENTATION ATTACHED TO PLANS AND INFORM THE CLIENT OF ANY CONSEQUENCES RESULTING FROM CHANGES TO PLAN IF APPLICABLE.

- THE DIMENSIONS ON THE PLAN HAVE PRIORITY ON THE DRAWING. CERTAIN DIMENSIONS MAY VARY ACCORDING TO THE MATERIAL USED AND/ OR THE CONTRACTOR'S BUILDING METHODS. IF VARIATIONS EXIST BETWEEN THE BUILDING SITE AND PLANS, THE CONTRACTOR MUST ADVISE DRUMMOND HOUSE PLANS INC. AS SOON AS POSSIBLE.

IMPORTANT NOTES:

-THE CONCRETE USED MUST BE PRODUCED AND DELIVERED BY A FACTORY THAT HAS CERTIFICATE OF CONFORMITY.

-AN APPLICATION OF WOOD PRESERVATIVE IS REQUIRED AT THE EXTREMITIES OF THE BEAMS OR ELEMENTS SUPPORTED ON MASONRY

- ALL EXTERIOR COATINGS MUST BE INSTALLED AS PER MANUFACTURER SPECIFICATIONS.

- MINIMUM FOUNDATION DEPTH BELOW FINISHED GRADE IS 4'-6", THIS DEPTH MAY VARY ACCORDING TO LOCAL CODE REQUIREMENTS.

- ENDS OF STEEL BEAMS SUPPORTED ON EXTERIOR WALL MUST BE INSULATED ON A MINIMUM LENGTH OF 24".

- TO PROTECT AGAINST FROST HEAVE ON ALL CONCRETE FOUNDATIONS WALLS, PILASTER AND CONCRETE ANGLES, MUST BE COVERED WITH EITHER A PROTECTIVE MEMBRANE, 15 LBS ASPHALT PAPER, POLYETHYLENE, RIGID INSULATION OR 1/2" TAR FIBERBOARD.

- 2" MINIMUM SPACE IS REQUIRED BETWEEN THE ROOF AREA AND

-IT IS MANDATORY TO VENTILATE THE ROOF ADEQUATELY. THE VENTILATORS CHOSEN BY THE CUSTOMER AND/OR THE CONTRACTOR WILL BE REQUIRED TO RESPECT THE CURRENT BUILDING CODE.

- THE WINDOW DIMENSIONS IN THIS PLAN MAY VARY DEPENDING ON THE CHOSEN MANUFACTURER. THE WINDOWS MUST COMPLY WITH THE NORTH AMERICAN STANDARD (AAMA / WDMA / CSA). CATEGORY R IS THE MINIMUM CLASSIFICATION LEVEL ACCEPTED.

- ALL VAPOR BARRIERS INDICATED IN THIS PLAN SHOULD BE SEALED WHEN THEY OVERLAP AND AROUND OPENINGS. IT IS IMPORTANT TO INSTALL A VAPOR BARRIER AT THE BACK OF THE ELECTRIC BOXES AND THE SEAL IT.

STRUCTURAL NOTES:

- FRAMING LUMBER (BEAMS, LINTELS, JOISTS) TO BE GRADE NO 1 & 2 SPRUCE UNLESS OTHERWISE INDICATED.

- ALL LINTELS TO BE 2-2"X10" UNLESS OTHERWISE SPECIFIED.

- ALL POSTS IN EXTERIOR WALL TO BE MIN. 3-2"X6" UNLESS OTHERWISE SPECIFIED

- ALL INTERIOR POSTS TO BE MIN. 3-2"X4" UNLESS OTHERWISE

-THE TRUSS AND THE PREFABRICATED JOIST MANUFACTURER MUST VERIFY THAT ALL DIMENSIONS ARE IN COMPLIANCE WITH THE PLAN. FOLLOWING THE MANUFACTURER'S CALCULATIONS, SOME DIMENSIONS MAY REQUIRE CERTAIN ADJUSTMENTS. THE MANUFACTURER WILL BE FULLY RESPONSIBLE OF TRUSS AND FLOOR DESIGN AND WILL MAKE SURE THEY MEET THE ENGINEERING STANDARDS AND REGULATIONS.

- TEMPORARY AND PERMANENT TRUSS BRACING MUST BE INSTALLED AS PER TRUSS MANUFACTURER AND CODE REGULATIONS.

- THE PLYWOOD PANELS MAY BE REPLACED BY AN ORIENTED STRESS BOARD PANEL (OSB) OR EQUIVALENT.

- PROVIDE BRACING IN ALL EXTERIOR WALL CORNERS. BRACING CAN BE MADE OF 1/2" PLYWOOD, 1/2" OSB OR STEEL BRACING INSTALLED AT 45° ANGLE.

- IN A MASONRY WALL, THE HORIZONTAL STEEL CLAMPS ARE TO BE PLACED AT A MAX. 3'-0" SPACING, THE VERTICAL ONES AT 16" MAX. THE SIZE OF THE STEEL LINTELS (OVER OPENINGS) TO BE DETERMINED BY THE MACON.

IN-WALL STUD POST

REINFORCED BEAMS
SUPPORTING STRUCTURE

BEARING WALL


CROSS SECTION

-ARROW INDICATING
THE DIRECTION OF CUT

-SECTION NUMBER
-PAGE ON WHICH
SECTION IS FOUND
-PAGE ON WHICH
SECTION WAS TAKEN

This plan is strictly protected by copyright laws.
Only the original purchaser of this plan is authorized to use this construction drawing.
This plan cannot be sold, distributed, or transferred to any other person.
Violators may be prosecuted.
For more information:

Drummond House Plans 1.800.567.5267

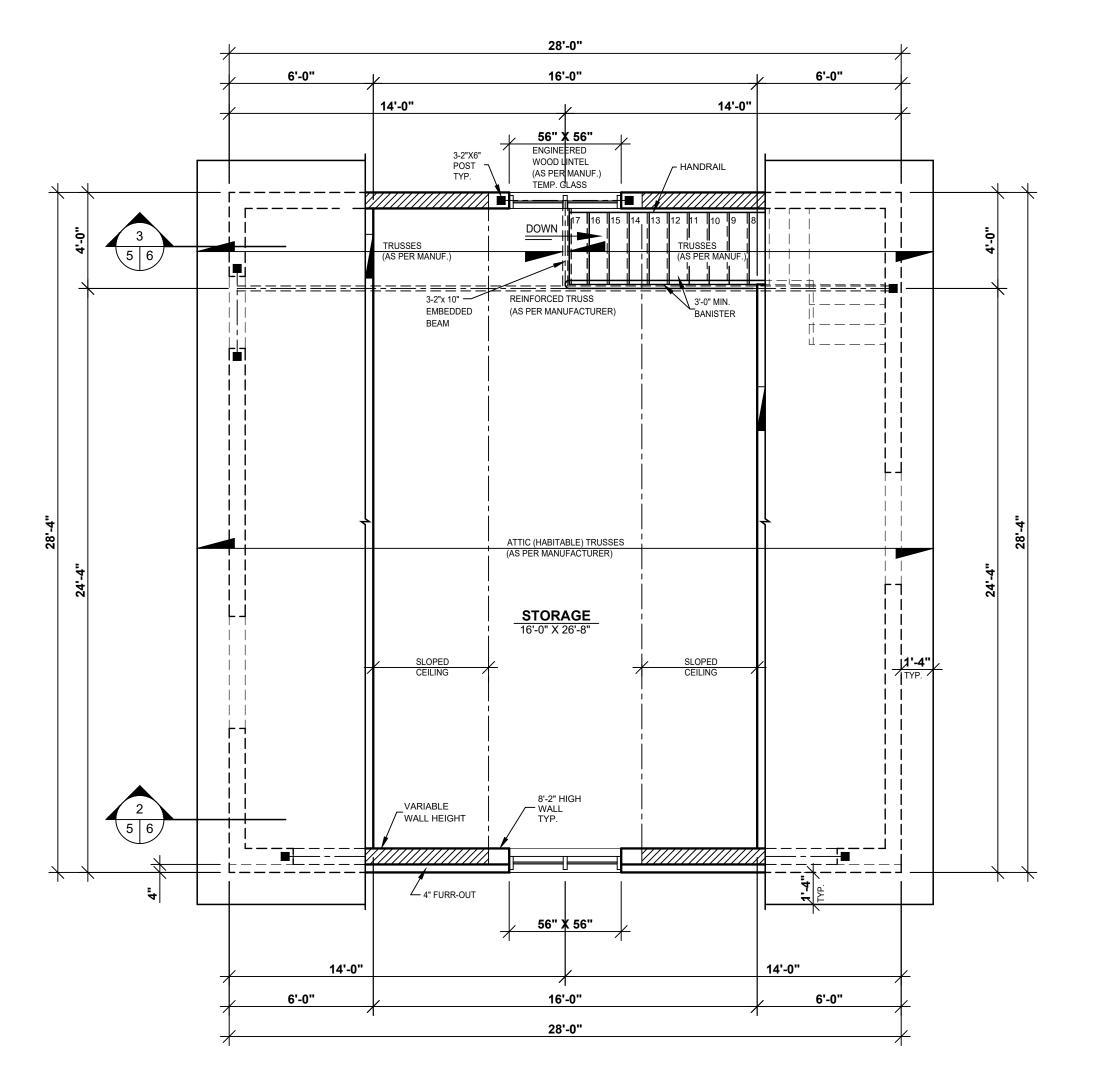

DRUMMOND HOUSE PLANS

info@drummondhouseplans.com

1-800-567-5267



NOTES:

THESE PLANS HAVE BEEN DRAWN ACCORDING TO HIGH QUALITY STANDARDS AND PRACTICES AND ARE AN ACCURATE GUIDE TO BUILDING CONSTRUCTION. HOWEVER, LOCAL REGULATIONS AND LOCAL BUILDING CODE REQUIREMENTS VARY, AND AS SUCH, MAY REQUIRE CHANGES. THE BUILDING CODE REQUIREMENTS VARY, AND AS SUCH, MAY REQUIRE CHANGES. THE BUILDING CONFORM TO ALL CURRENT GOVERNMENTAL AND/OR BUILDING CODE REQUIREMENTS IN THE MUNICIPALITY WHERE THE HOME WILL BE BUILT. THE CLIENT IS RESPONSIBLE FOR THE VERIFICATION OF MUNICIPAL REGULATIONS. DRUMMOND DESIGNS INC, WILL NOT ASSUME LIABILITY FOR MISHAPS BEFORE, DURING, OR AFTER THE USE OF THESE PLANS FOR CONSTRUCTION.

THIS GARAGE PLAN HAS BEEN ORIGINALLY DRAWN BY DRUMMOND DESIGNS INC. AND IS ITS EXCLUSIVE PROPERTY. ANY REPRODUCTION IS STRICTLY FORBIDDEN. THE PURCHASE OF A GARAGE PLAN DOES NOT INCLUDE THE LICENSE FOR ADVERTISING USE; THIS LICENSE CAN BE PURCHASE UPON REQUEST. THE PURCHASE OF A LICENSE IS REQUIRED IF MORE THAN ONE GARAGE IS TO BE BUILT WITH THIS GARAGE PLAN.

YOUR CITY OR STATE MAY REQUIRE THAT YOU HAVE A CERTIFIED ARCHITECT OR ENGINEER APPROVE YOUR PLANS AND AFFIX HIS SEAL TO THE PLANS FOR SAFETY REASONS OR PARTICULAR REGULATIONS.



BRYAN NORWALT (603)365-6061

REVISION		NO	DATE	BY
STAMP BY:				

NEW CONSTRUCTION

All Rights Res

COM

HOUSEPLANS,

DRUMMOND

SECOND FLOOR PLAN

DESIGNED	BY	DRAWN BY		CHECKED BY
	D.C.	A.F	₹0.	M.S.
DATE	00	0/00/2021	SCALE	1/4"=1'-0"
PLAN NO.		2989-28	SHEET	NO. 5-7

This plan is strictly protected by copyright laws.
Only the original purchaser of this plan is authorized to use this construction drawing.
This plan cannot be sold, distributed, or transferred to any other person.
Violators may be prosecuted.
For more information:
Drummond House Plans 1.800.567.5267


THE TRUSS DIAGRAMS ON THIS PLAN ARE ONLY SHOW FOR SCHEMATIC PURPOSE. IT IS THE MANUFACTUER'S RESPONSABILITY TO DESIGNE AND CONCIVE THE TRUSSES TO MEET AND COMPLY LOCAL AND CODE REGULATION.

DRUMMOND HOUSE PLANS

info@drummondhouseplans.com

1-800-567-5267



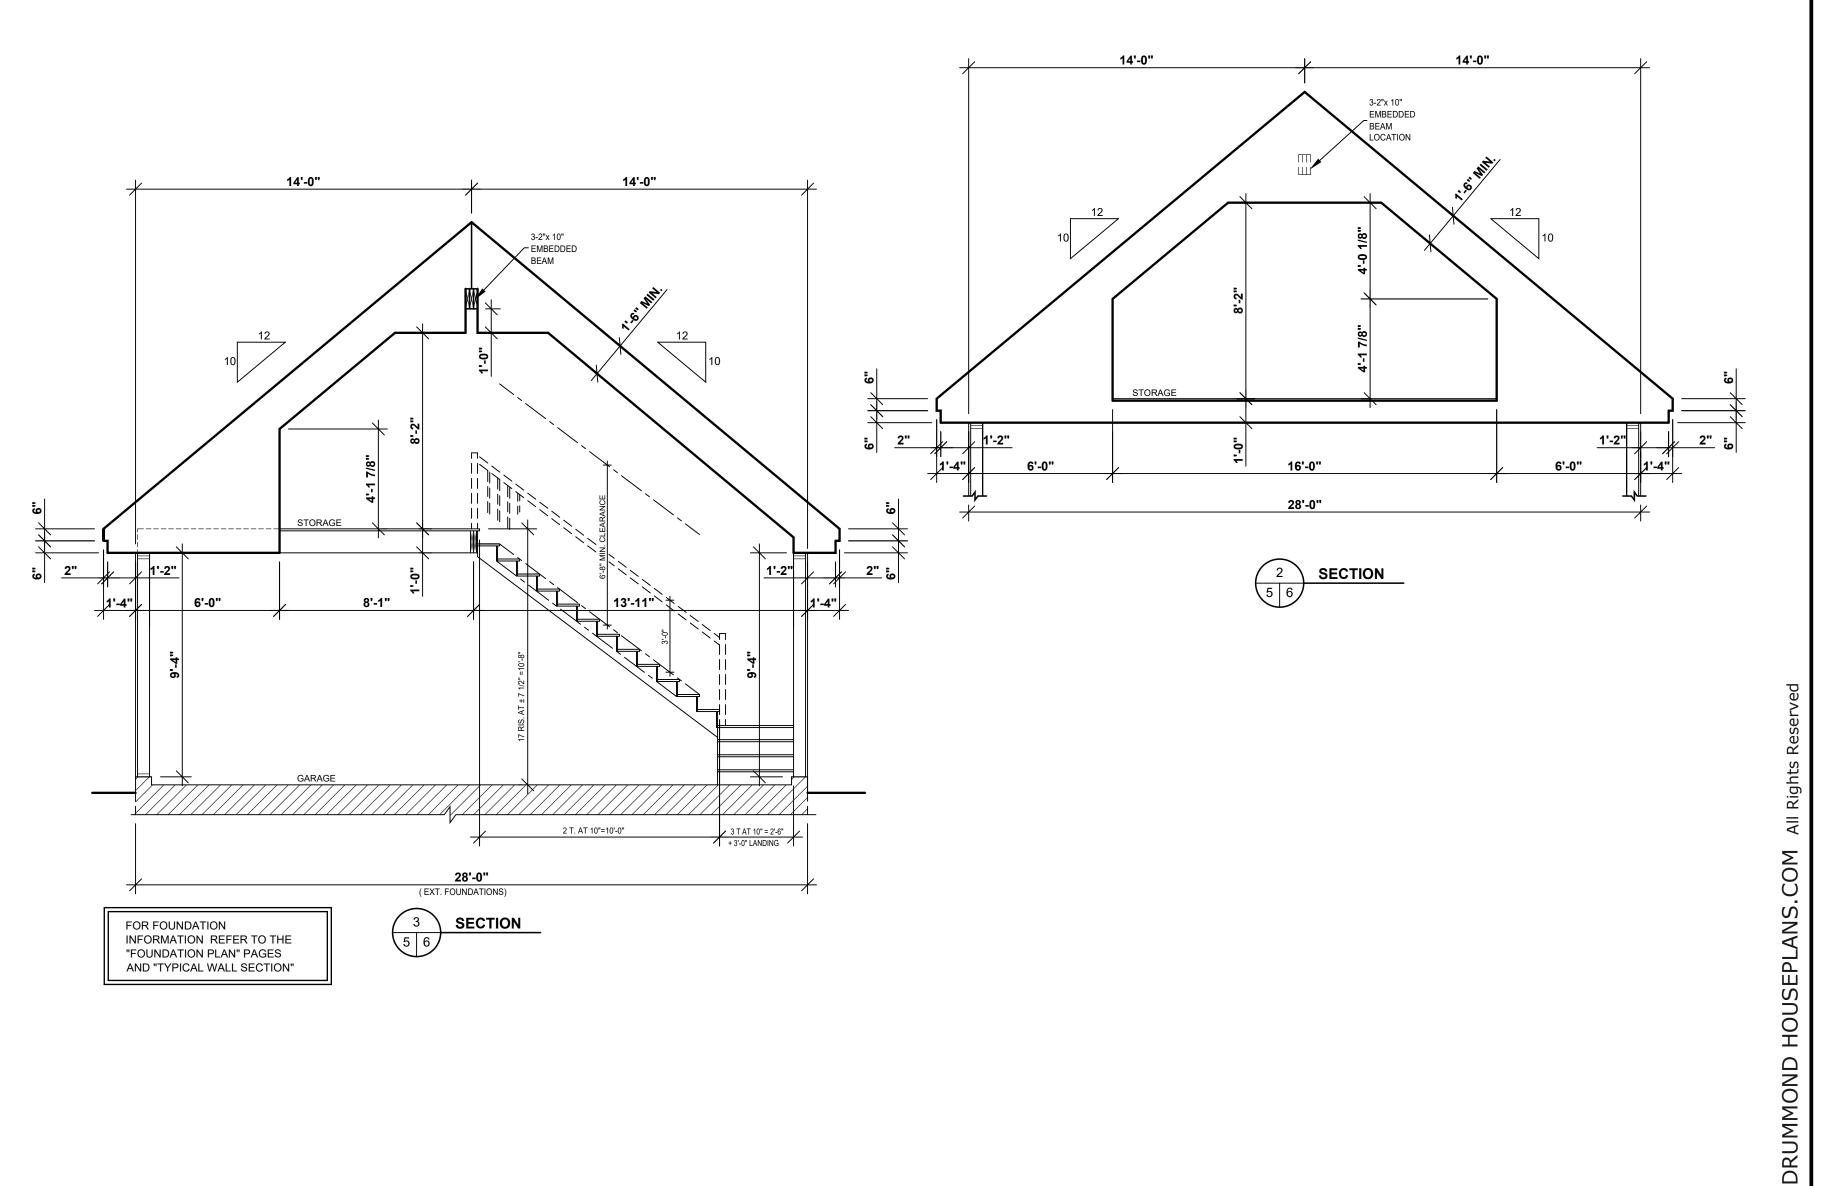

NOTES:

THESE PLANS HAVE BEEN DRAWN ACCORDING TO HIGH QUALITY STANDARDS AND PRACTICES AND ARE AN ACCURATE GUIDE TO BUILDING CONSTRUCTION. HOWEVER, LOCAL REGULATIONS AND LOCAL BUILDING CODE REQUIREMENTS VARY, AND AS SUCH, MAY REQUIRE CHANGES. THE BUILDING CONTRACTOR MUST REVISE AND ENSURE WITH HIS CLIENT THAT THE PLANS CONFORM TO ALL CURRENT GOVERNMENTAL AND/OR BUILDING CODE REQUIREMENTS IN THE MUNICIPALITY WHERE THE HOME WILL BE BUILT. THE CLIENT IS RESPONSIBLE FOR THE VERIFICATION OF MUNICIPAL REGULATIONS. DRUMMOND DESIGNS INC, WILL NOT ASSUME LIABILITY FOR MISHAPS BEFORE, DURING, OR AFTER THE USE OF THESE PLANS FOR CONSTRUCTION.

THIS GARAGE PLAN HAS BEEN ORIGINALLY DRAWN BY DRUMMOND DESIGNS INC. AND IS ITS EXCLUSIVE PROPERTY. ANY REPRODUCTION IS STRICTLY FORBIDDEN. THE PURCHASE OF A GARAGE PLAN DOES NOT INCLUDE THE LICENSE FOR ADVERTISING USE; THIS LICENSE CAN BE PURCHASE UPON REQUEST. THE PURCHASE OF A LICENSE IS REQUIRED IF MORE THAN ONE GARAGE IS TO BE BUILT WITH THIS GARAGE PLAN.

YOUR CITY OR STATE MAY REQUIRE THAT YOU HAVE A CERTIFIED ARCHITECT OR ENGINEER APPROVE YOUR PLANS AND AFFIX HIS SEAL TO THE PLANS FOR SAFETY REASONS OR PARTICULAR REGULATIONS.



BRYAN NORWALT
(603)365-6061


RE	VISION	NO	DATE	BY
STAMP BY:				

NEW CONSTRUCTION

DRAWII

TRUSS DIAGRAM

D.C. A.RO. M.S. DATE 00/00/2021 SCALE 1/4"=1'-0" PLAN NO. 2989-28 SHEET NO. 6-7	DEGIGINED D1		DIVAVVIV D I		CHECKED BT
00/00/2021 1/4"=1'-0" PLAN NO. SHEET NO.		D.C.	A.F	RO.	M.S.
	DATE	00	0/00/2021	SCALE	1/4"=1'-0"
	PLAN NO.		2989-28	SHEET	

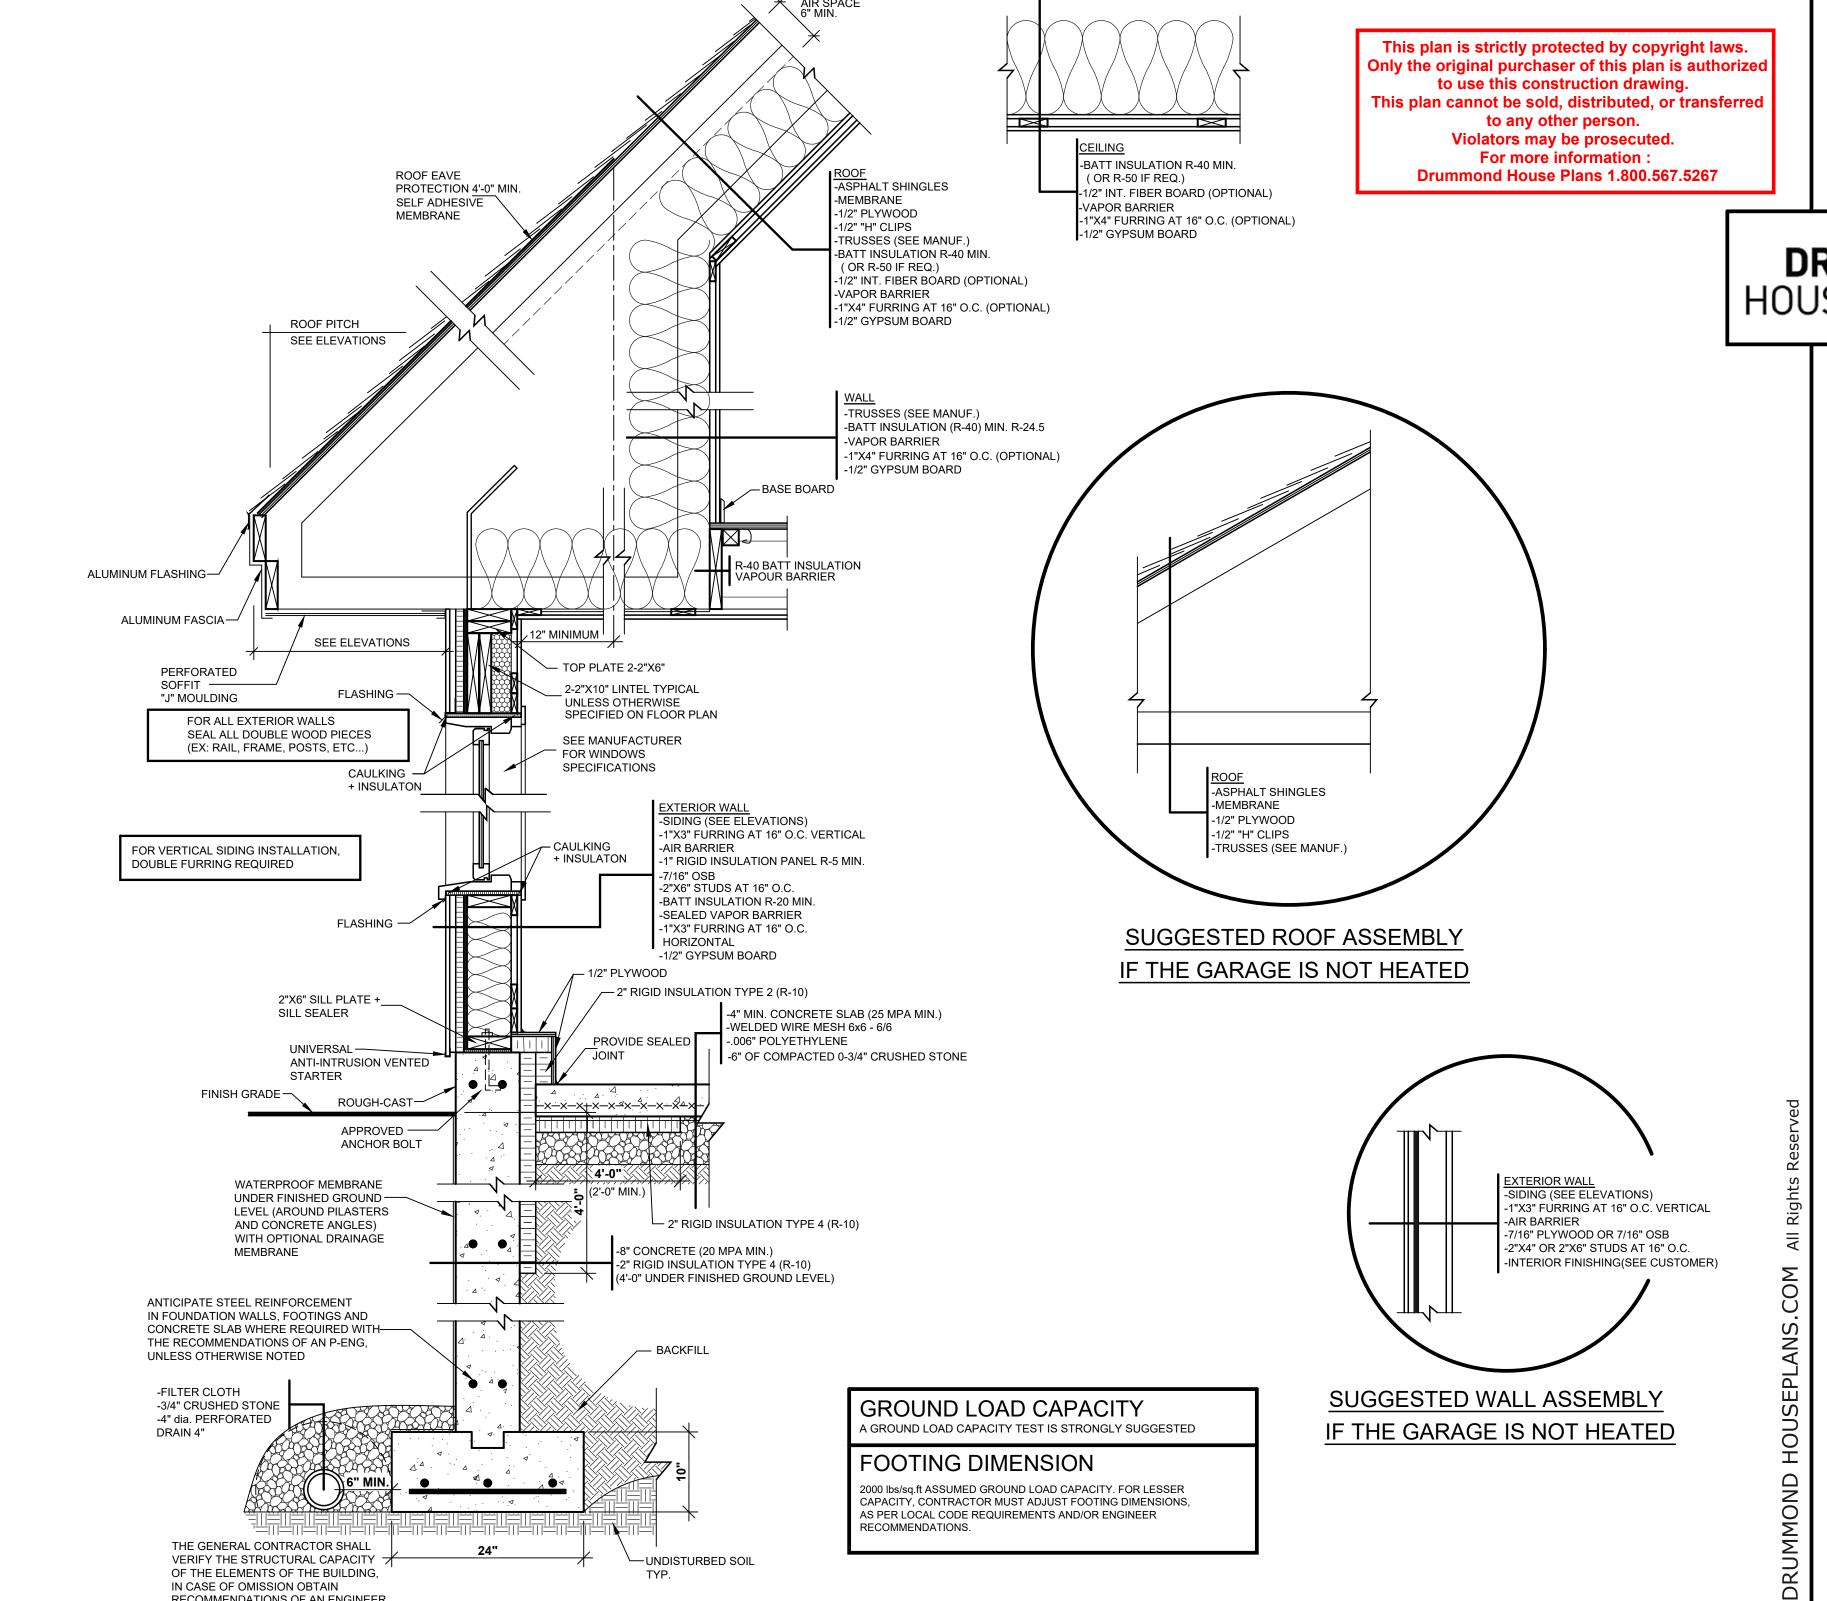

UNDISTURBED SOIL

THE GENERAL CONTRACTOR SHALL VERIFY THE STRUCTURAL CAPACITY 7

OF THE ELEMENTS OF THE BUILDING, IN CASE OF OMISSION OBTAIN RECOMMENDATIONS OF AN ENGINEER DRUMMOND HOUSE PLANS

info@drummondhouseplans.com

1-800-567-5267




THESE PLANS HAVE BEEN DRAWN ACCORDING TO HIGH QUALITY STANDARDS AND PRACTICES AND ARE AN ACCURATE GUIDE TO BUILDING CONSTRUCTION HOWEVER, LOCAL REGULATIONS AND LOCAL BUILDING CODE REQUIREMENTS VARY, AND AS SUCH, MAY REQUIRE CHANGES. THE BUILDING CONTRACTOR MUS REVISE AND ENSURE WITH HIS CLIENT THAT THE PLANS CONFORM TO ALL CURRENT GOVERNMENTAL AND/OR BUILDING CODE REQUIREMENTS IN THE MUNICIPALITY WHERE THE HOME WILL BE BUILT. THE CLIENT IS RESPONSIBLE FOI THE VERIFICATION OF MUNICIPAL REGULATIONS. DRUMMOND DESIGNS INC, WILL NOT ASSUME LIABILITY FOR MISHAPS BEFORE, DURING, OR AFTER THE USE OF THESE PLANS FOR CONSTRUCTION.

THIS GARAGE PLAN HAS BEEN ORIGINALLY DRAWN BY DRUMMOND DESIGNS INC THIS GARAGE PLAN HAS BEEN ORIGINALLY DRAWN BY DROMMIND LESIONS INC AND IS ITS EXCLUSIVE PROPERTY. ANY REPRODUCTION IS STRICTLY FORBIDDEN THE PURCHASE OF A GARAGE PLAN DOES NOT INCLUDE THE LICENSE FOR ADVERTISING USE; THIS LICENSE CAN BE PURCHASE UPON REQUEST. THE PURCHASE OF A LICENSE IS REQUIRED IF MORE THAN ONE GARAGE IS TO BE BUILT WITH THIS GARAGE PLAN.

YOUR CITY OR STATE MAY REQUIRE THAT YOU HAVE A CERTIFIED ARCHITECT OR ENGINEER APPROVE YOUR PLANS AND AFFIX HIS SEAL TO THE PLANS FOR SAFETY REASONS OR PARTICULAR REGULATIONS.




BRYAN NORWALT (603)365-6061

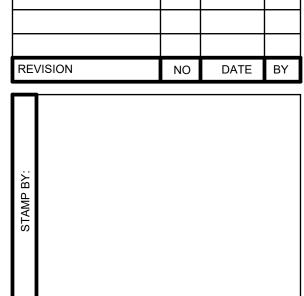

NEW CONSTRUCTION

TYPICAL WALL SECTION (FLOATING SLAB)

DESIGNED E	3Y	DRAWN BY		CHECKED BY
	D.C.	A.F	RO.	M.S.
DATE	00	0/00/2021	SCALE	1"=1'-0"
PLAN NO.		2989-28	SHEET	7a-7

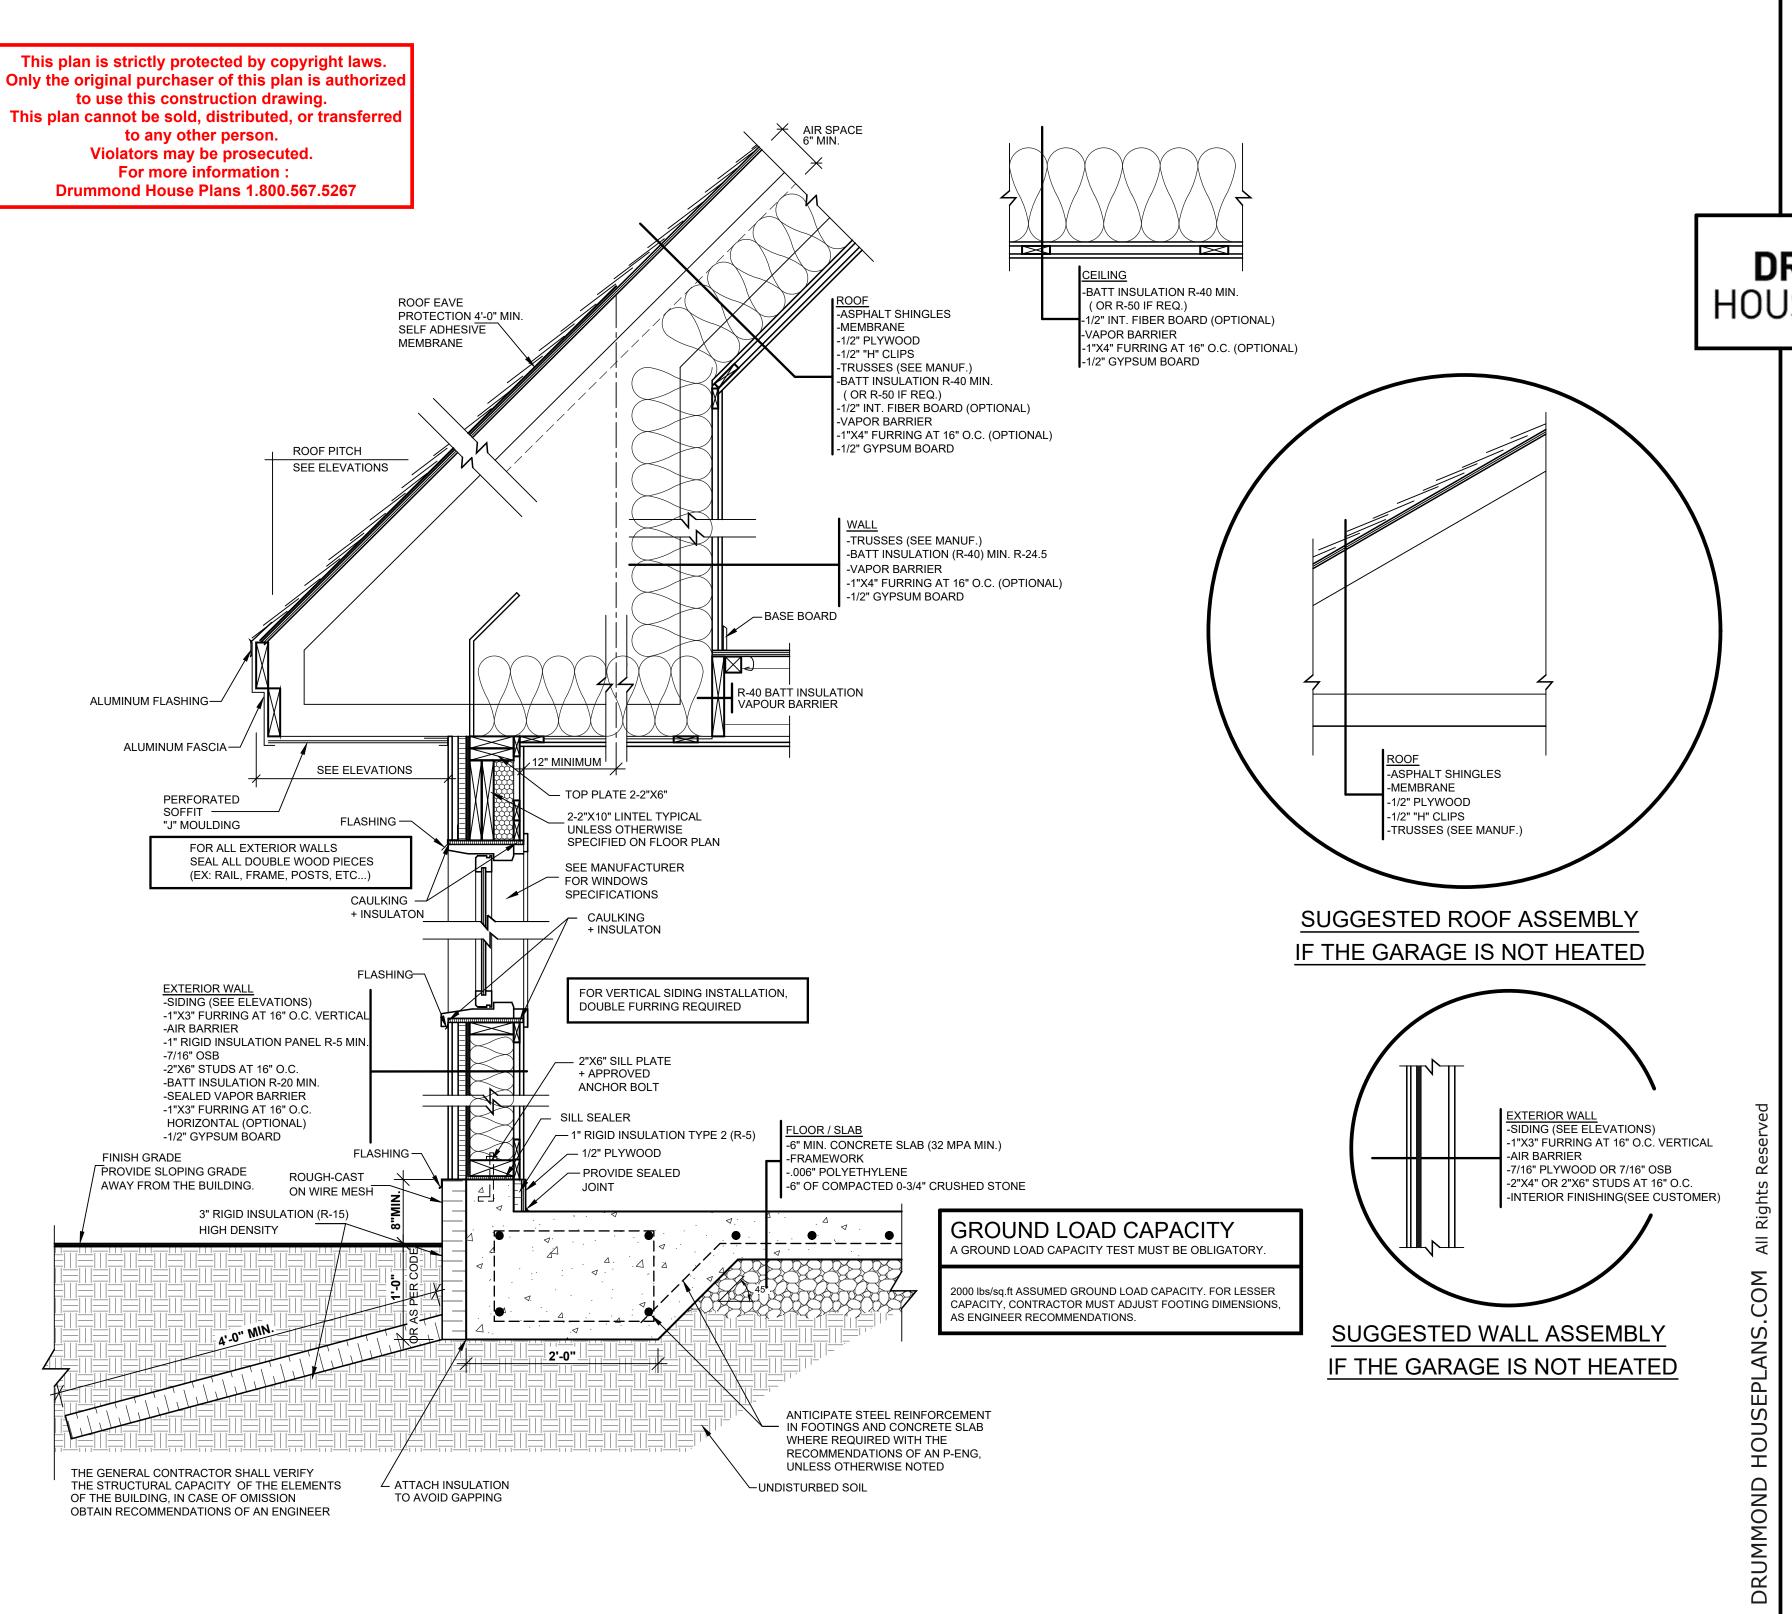

DRUMMOND HOUSE PLANS

info@drummondhouseplans.com

1-800-567-5267

DRUMMOND HOUSE PLANS

NOTES:


THESE PLANS HAVE BEEN DRAWN ACCORDING TO HIGH QUALITY STANDARDS AND PRACTICES AND ARE AN ACCURATE GUIDE TO BUILDING CONSTRUCTION. HOWEVER, LOCAL REGULATIONS AND LOCAL BUILDING CODE REQUIREMENTS VARY, AND AS SUCH, MAY REQUIRE CHANGES. THE BUILDING CONTRACTOR MUST REVISE AND ENSURE WITH HIS CLIENT THAT THE PLANS CONFORM TO ALL CURRENT GOVERNMENTAL AND/OR BUILDING CODE REQUIREMENTS IN THE MUNICIPALITY WHERE THE HOME WILL BE BUILT. THE CLIENT IS RESPONSIBLE FOR THE VERIFICATION OF MUNICIPAL REGULATIONS. DRUMMOND DESIGNS INC, WILL NOT ASSUME LIABILITY FOR MISHAPS BEFORE, DURING, OR AFTER THE USE OF THESE PLANS FOR CONSTRUCTION.

THIS GARAGE PLAN HAS BEEN ORIGINALLY DRAWN BY DRUMMOND DESIGNS INC. AND IS ITS EXCLUSIVE PROPERTY. ANY REPRODUCTION IS STRICTLY FORBIDDEN. THE PURCHASE OF A GARAGE PLAN DOES NOT INCLUDE THE LICENSE FOR ADVERTISING USE; THIS LICENSE CAN BE PURCHASE UPON REQUEST. THE PURCHASE OF A LICENSE IS REQUIRED IF MORE THAN ONE GARAGE IS TO BE BUILT WITH THIS GARAGE PLAN.

YOUR CITY OR STATE MAY REQUIRE THAT YOU HAVE A CERTIFIED ARCHITECT OR ENGINEER APPROVE YOUR PLANS AND AFFIX HIS SEAL TO THE PLANS FOR SAFETY PRASONS OR PARTICIL AR PEGII ATIONS



BRYAN NORWALT
(603)365-6061

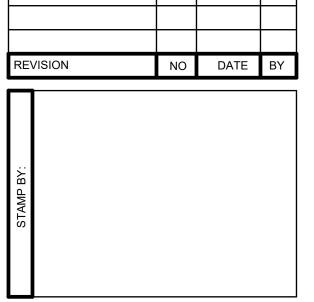

OJECT INFO

NEW CONSTRUCTION

TYPICAL WALL SECTION (MONOLITHIC SLAB)

DESIGNED BY		DRAWN BY		CHECKED BY
	D.C.	A.F	RO.	M.S.
DATE	00/00/2021		1"=1'-0"	
PLAN NO.		2989-28	SHEET	7b-7