
MAP 2, LOT 109 SITE PLAN

# PROPOSED DENTAL OFFICE

108 PONEMAH ROAD

AMHERST, NEW HAMPSHIRE

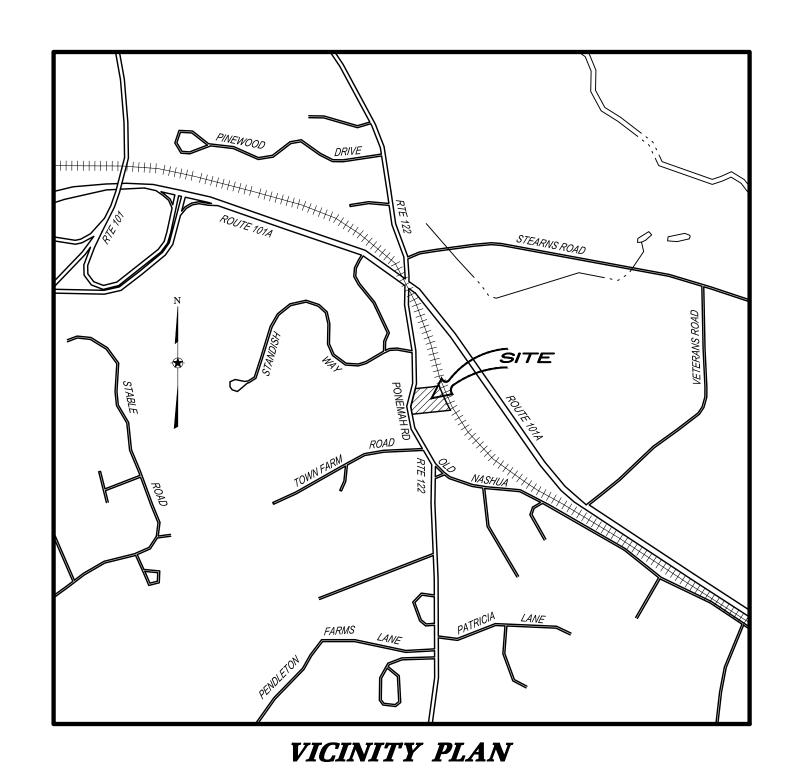

# PREPARED FOR/RECORD OWNER

# AZ REALTY, LLC


12 GILBOA LANE NASHUA, NEW HAMPSHIRE 03062 (603)672-6546


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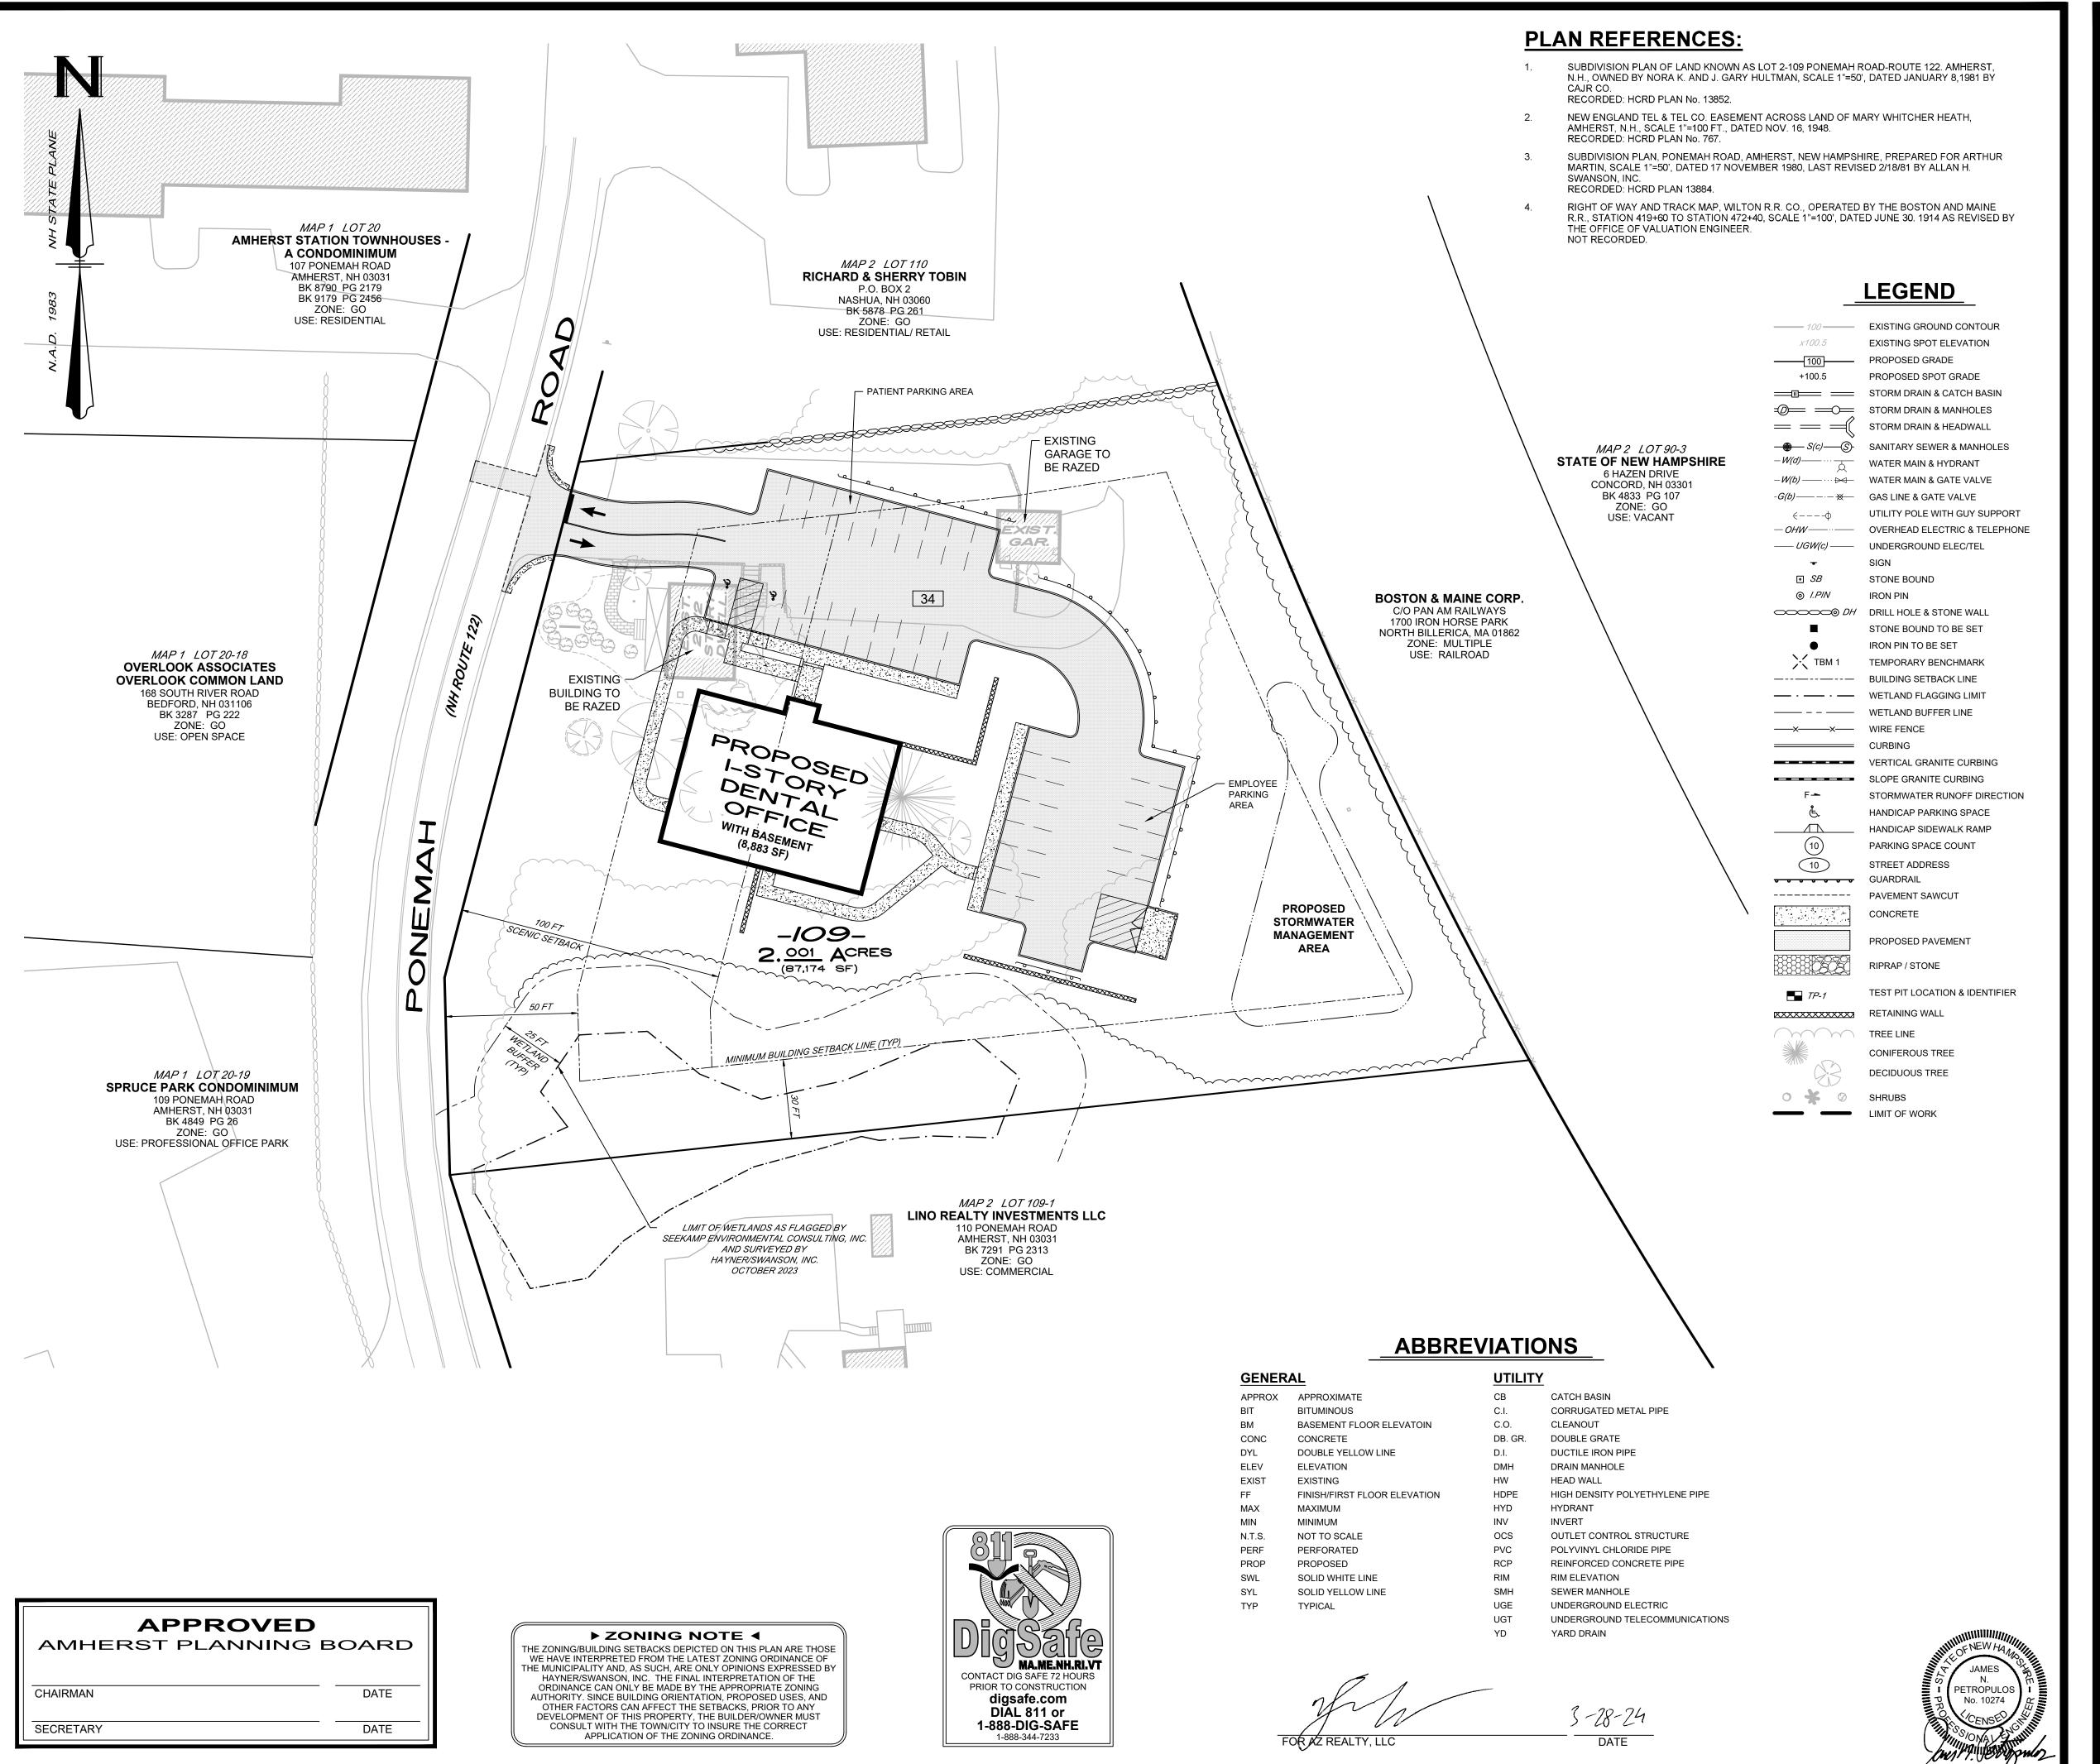
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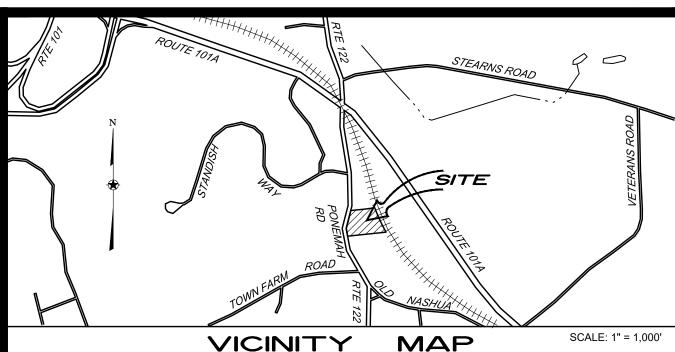


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(603) 883-2057
Www.hayner-swanson.com
Civil Engineers/Land Surveyors
131 Middlesex Turnpike
Burlington, MA 01803
(781) 203-1501





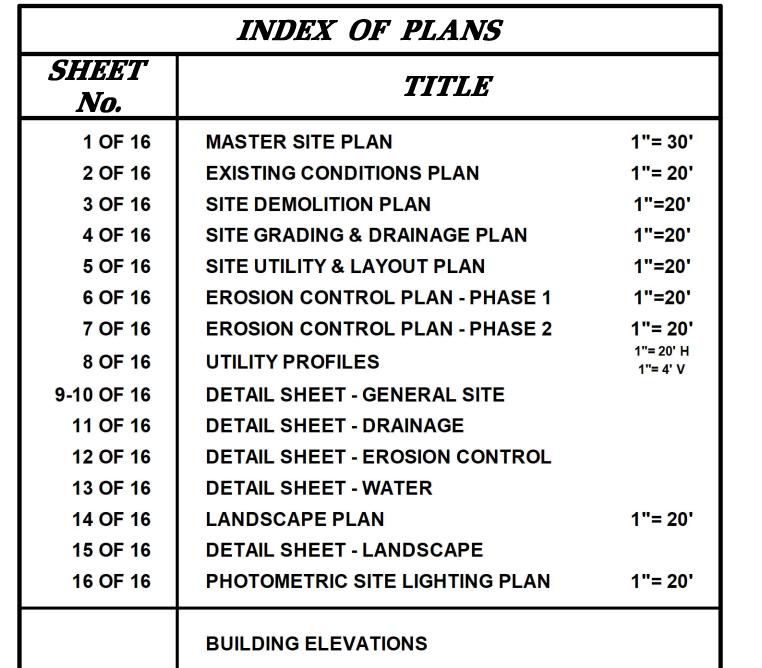

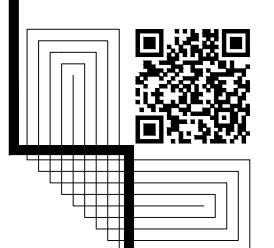

# **NOTES:**

LOT AREA: 2.001 ACRES (87,174 SF)

PRESENT ZONING: GO – GENERAL OFFICE

DIMENSIONAL REQUIREMENTS:

MIN. LOT AREA 1 ACRE

MIN. FRONTAGE 200 FT

MIN. FRONT SETBACK 100 FT

MIN. SIDE SETBACK 30 FT

MIN. REAR SETBACK 30 FT

MAX. BUILDING HEIGHT 40 FT

NOTE: ON FEBRUARY 20, 2024 THE AMHERST ZONING BOARD OF ADJUSTMENT GRANTED A VARIANCE OF ARTICLE III SECTION 3.11, PARAGRAPH B.1 TO ALLOW A BUILDING WHICH IS SET BACK 60 FT FROM A SCENIC ROAD WHERE A MINIMUM 100 FT SETBACK IS REQUIRED.

LOT NUMBERS REFER TO THE TOWN OF AMHERST ASSESSORS MAPS 1 & 2.

FLOOR AREA RATIO

PURPOSE OF PLAN:
TO SHOW A PROPOSED 1-STORY, 8,883 SF DENTAL OFFICE (WITH BASEMENT) ALONG

PROPOSED (INCLUDING 2 ACCESSIBLE SPACES):

WITH ASSOCIATED SITE IMPROVÉMENTS.

PARKING:
MINIMUM REQUIRED:

 OFFICE:
 4 SPACES/1,000 SF X 6,663 SF
 = 27 SPACES

 STORAGE (BASEMENT):
 1 SPACE /1,000 SF X 2,220 SF
 = 2 SPACES

 TOTAL:
 = 29 SPACES

= 34 SPACES

OPEN SPACE: MIN. REQUIRED:

MIN. REQUIRED: 30 % PROVIDED: 75 %

THE SUBJECT PARCEL IS LOCATED WITHIN ZONE X AND ZONE X SHADED, GRAPHICALLY DEPICTED ON THE FLOOD INSURANCE RATE MAP (FIRM), HILLSBOROUGH COUNTY, TOWN OF AMHERST, NEW HAMPSHIRE, COMMUNITY No. 330081, PREPARED BY THE FEDERAL EMERGENCY MANAGEMENT AGENCY, MAP NUMBER: 33011C0478D, REVISED DATE: SEPTEMBER 25, 2009.

ALL SIGNAGE SHALL CONFORM TO THE APPLICABLE TOWN OF AMHERST REGULATIONS.

SITE IMPROVEMENTS DEPICTED ON THE PLAN SHALL CONFORM WITH TITLE III OF THE AMERICANS

WITH DISABILITIES ACT WITH REGARD TO DIMENSION, GRADE AND NUMBER OF PARKING SPACES.

THIS PROJECT SHALL BE SERVICED BY A PRIVATE SEPTIC SYSTEM, WATER BY PENNICHUCK

WATER WORKS, GAS, AND UNDERGROUND ELECTRIC/COMMUNICATIONS UTILITIES.

1. THE SUBJECT PARCEL IS LOCATED WITHIN THE TOWN OF AMHERST AQUIFER CONSERVATION AND

12. A COMPLIANCE HEARING IS REQUIRED.

WELLHEAD PROTECTION DISTRICT.

3. DEBRIS CONTAINERS ARE REQUIRED ON SITE

STATE PERMITS/APPROVALS:

NEW HAMPSHIRE DEPARTMENT OF ENVIRONMENTAL SERVICES (NHDES) INDIVIDUAL SEWAGE DISPOSAL SYSTEM (ISDS) APPROVAL: (PENDING)

 NEW HAMPSHIRE DEPARTMENT OF TRANSPORTATION (NHDOT) DRIVEWAY PERMIT: (PENDING)

PRESENT OWNERS OF RECORD:

MAP 2, LOT 109 AZ REALTY, LLC 12 GILBOA LANE NASHUA, NH 03062

BK 9688, PG 177



MASTER SITE PLAN (MAP 2, LOT 109)

No. DATE

# PROPOSED DENTAL OFFICE 108 PONEMAH ROAD AMHERST, NEW HAMPSHIRE

REVISION

PREPARED FOR/RECORD OWNER:

# AZ REALTY, LLC 12 GILBOA LANE NASHUA, NEW HAMPSHIRE 03062

30 0 30 60 90 120 FEET

15 0 15 30 METERS

SCALE: 1"=30 Feet

1"=9.144 Meters

I APRIL 2024




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FIELD BOOK: 1276 DRAWING NAME: 5934—SITE—FQ31 5934—SITE

DRAWING LOC: J: \5000\5934\DWG\5934 SITE File Number Sheet

1 OF 16

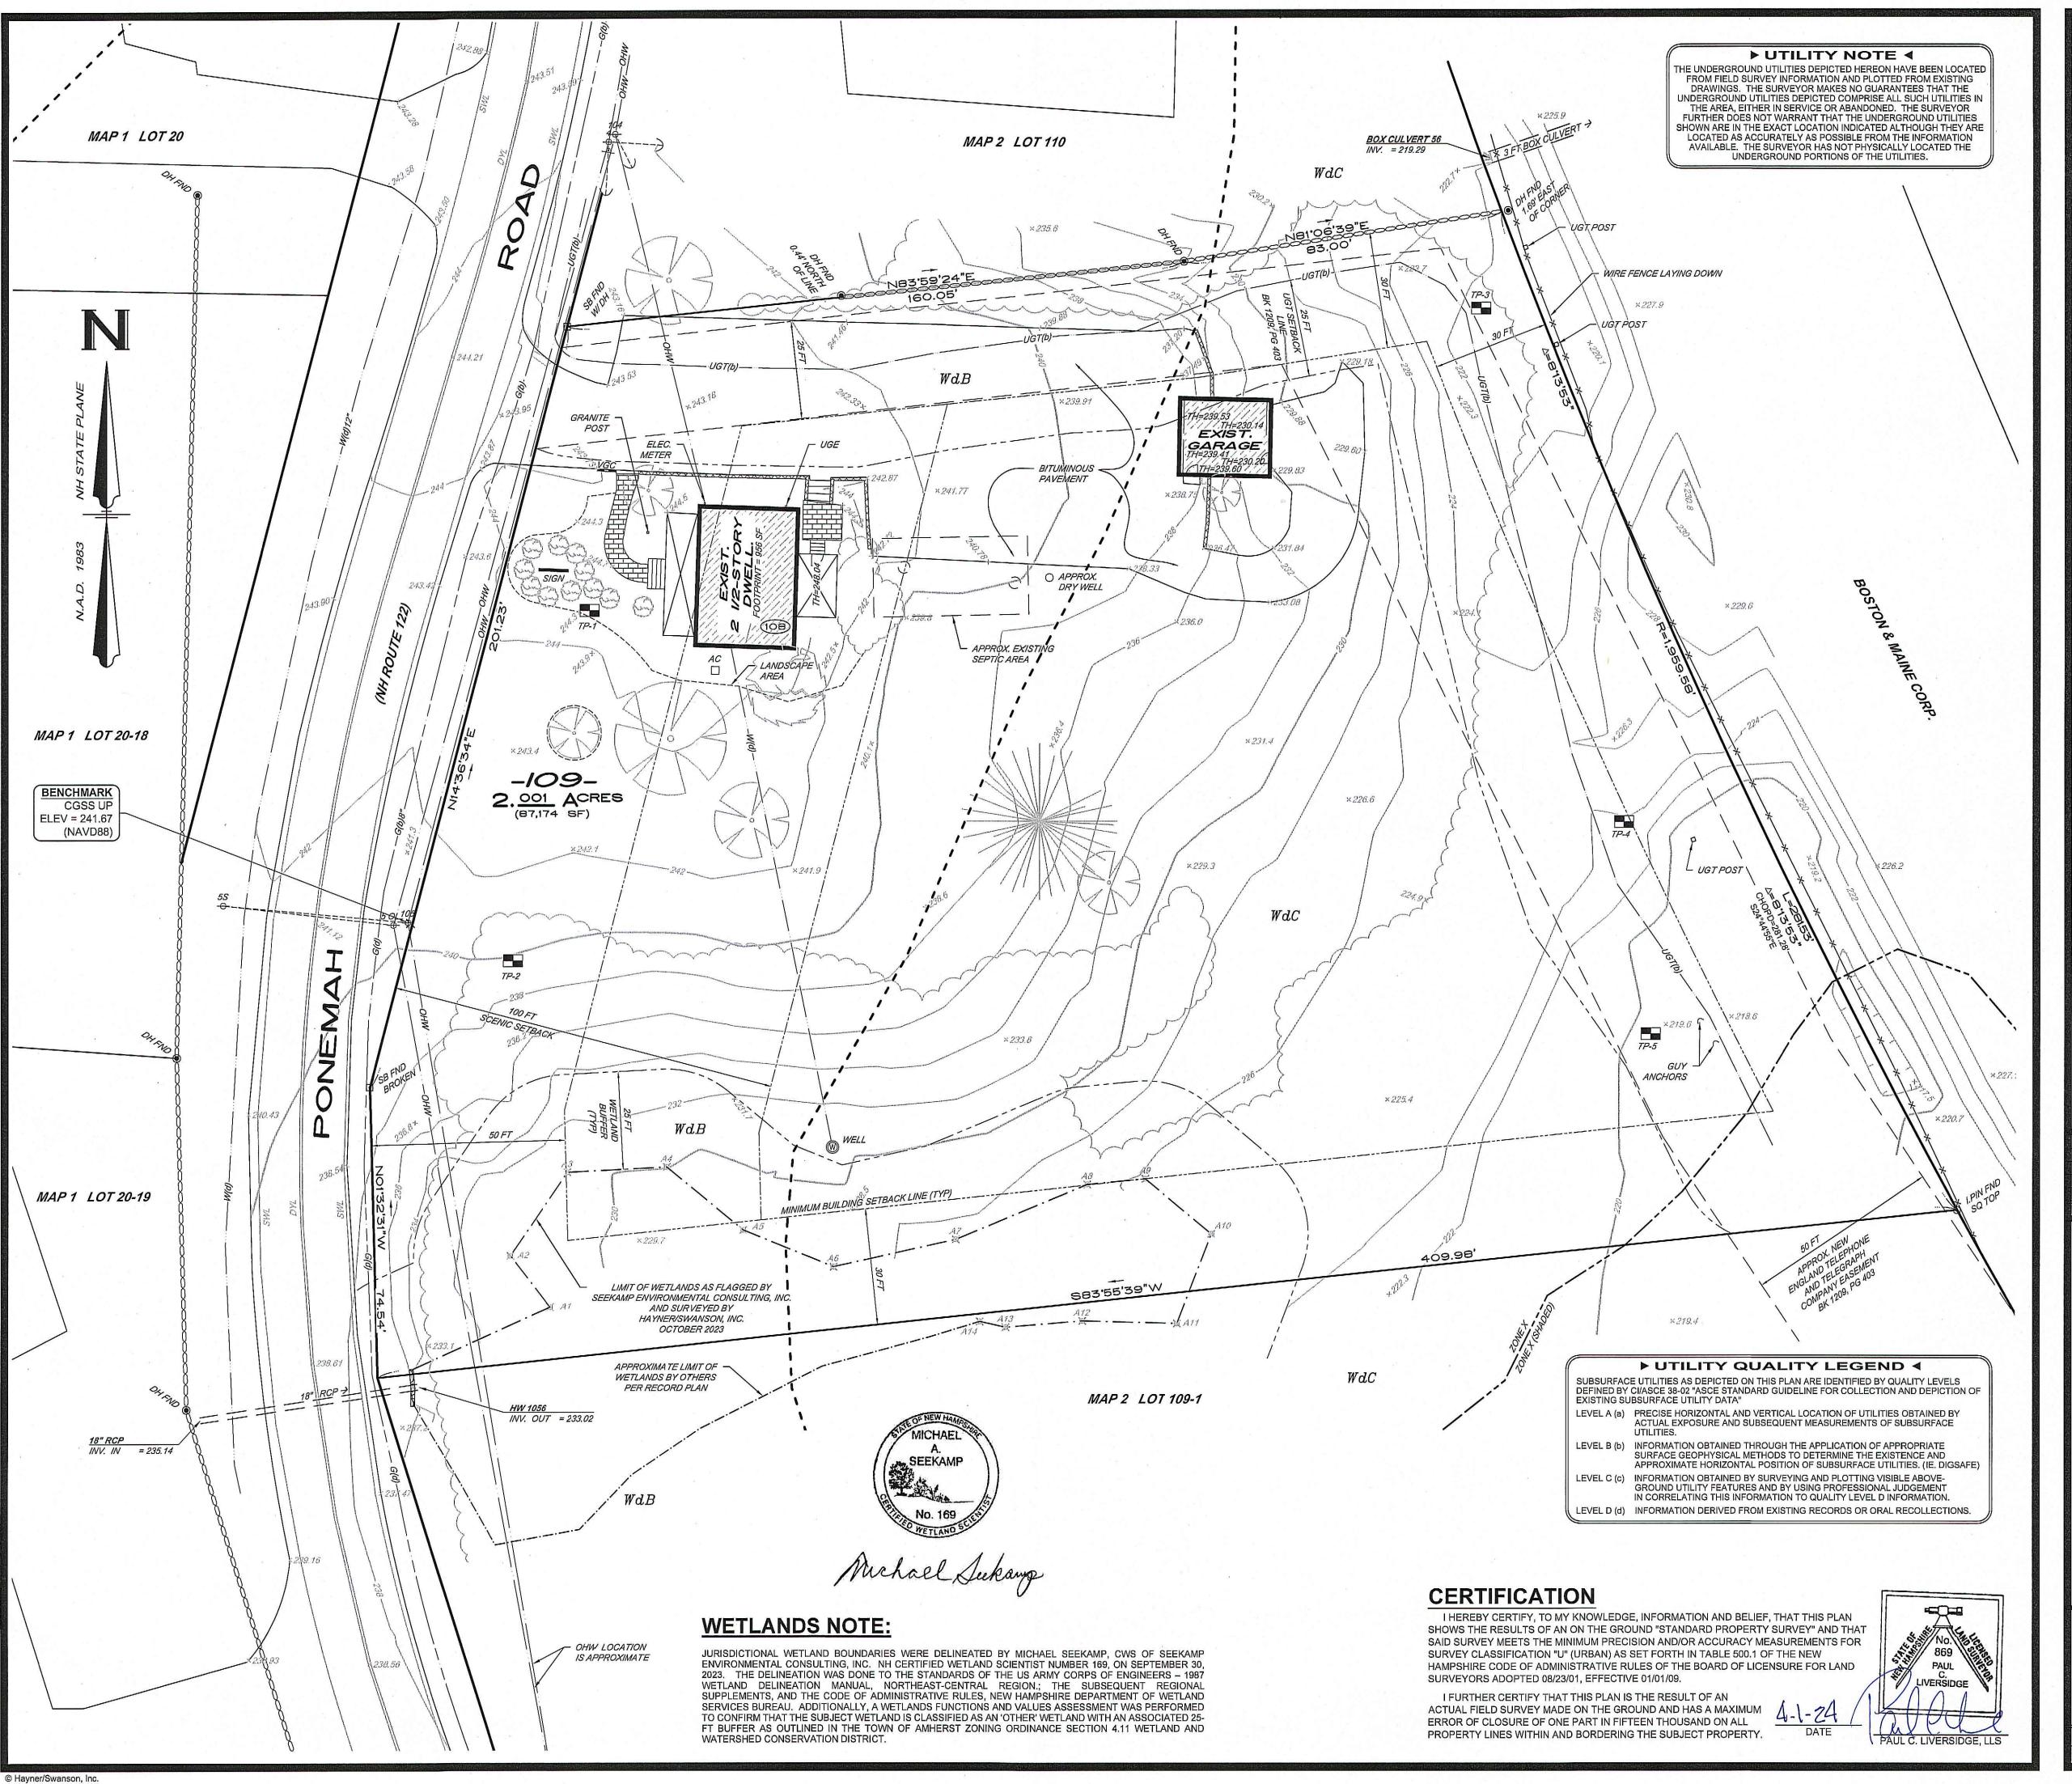

# **SURVEY NOTES:**

- THE EXISTING PLANIMETRICS AND TOPOGRAPHY, AS SHOWN ON THESE PLANS, IS BASED ON AN ACTUAL FIELD SURVEY MADE ON THE GROUND IN OCTOBER 2023.
- IT SHALL BE THE CONTRACTOR'S RESPONSIBILITY TO VERIFY THE ACCURACY OF THE EXISTING TOPOGRAPHY PRIOR TO EARTHWORK OPERATIONS. NO CLAIM FOR EXTRA WORK DUE TO TOPOGRAPHIC INACCURACY SHALL BE CONSIDERED AFTER EARTHWORK HAS COMMENCED.
- THE CONTRACTOR SHALL ONLY USE BENCHMARKS AS PROVIDED BY THE ENGINEER.
- SURVEY CONTROL INFORMATION:

UNITS: US SURVEY FEET.

- CONTROLLED BY TRIMBLE R-10 GPS RECEIVER. RTK CORRECTIONS VIA KEYNET VRS HORIZONTAL DATUM: NAD83 (2011) HORIZONTAL PROJECTION: NH STATE PLANE VERTICAL DATUM: NAVD88
- TEST PIT LOCATIONS AS SHOWN ARE APPROXIMATE AND WERE WITNESSED BY THIS OFFICE.

### **SOILS DATA**

WINDSOR SANDY LOAM, 0 TO 8 PERCENT SLOPES

WINDSOR SANDY LOAM, 8 TO 15 PERCENT SLOPES

SOIL BOUNDARY



EXISTING CONDITIONS PLAN

(MAP 2, LOT 109)

No. DATE

PROPOSED DENTAL OFFICE 108 PONEMAH ROAD AMHERST, NEW HAMPSHIRE

REVISION

PREPARED FOR / RECORD OWNER:

AZ REALTY, LLC

12 GILBOA LANE NASHUA, NEW HAMPSHIRE

SCALE: 1"=20 Feet 1"=6.096 Meters

APRIL 2024




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Nashua, NH 03062

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(781) 203-1501

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5934-SITE 2 OF 16 DRAWING LOC: J: \5000\5934\DWG\5934 SITE File Number



# **SITE DEMOLITION NOTES:**

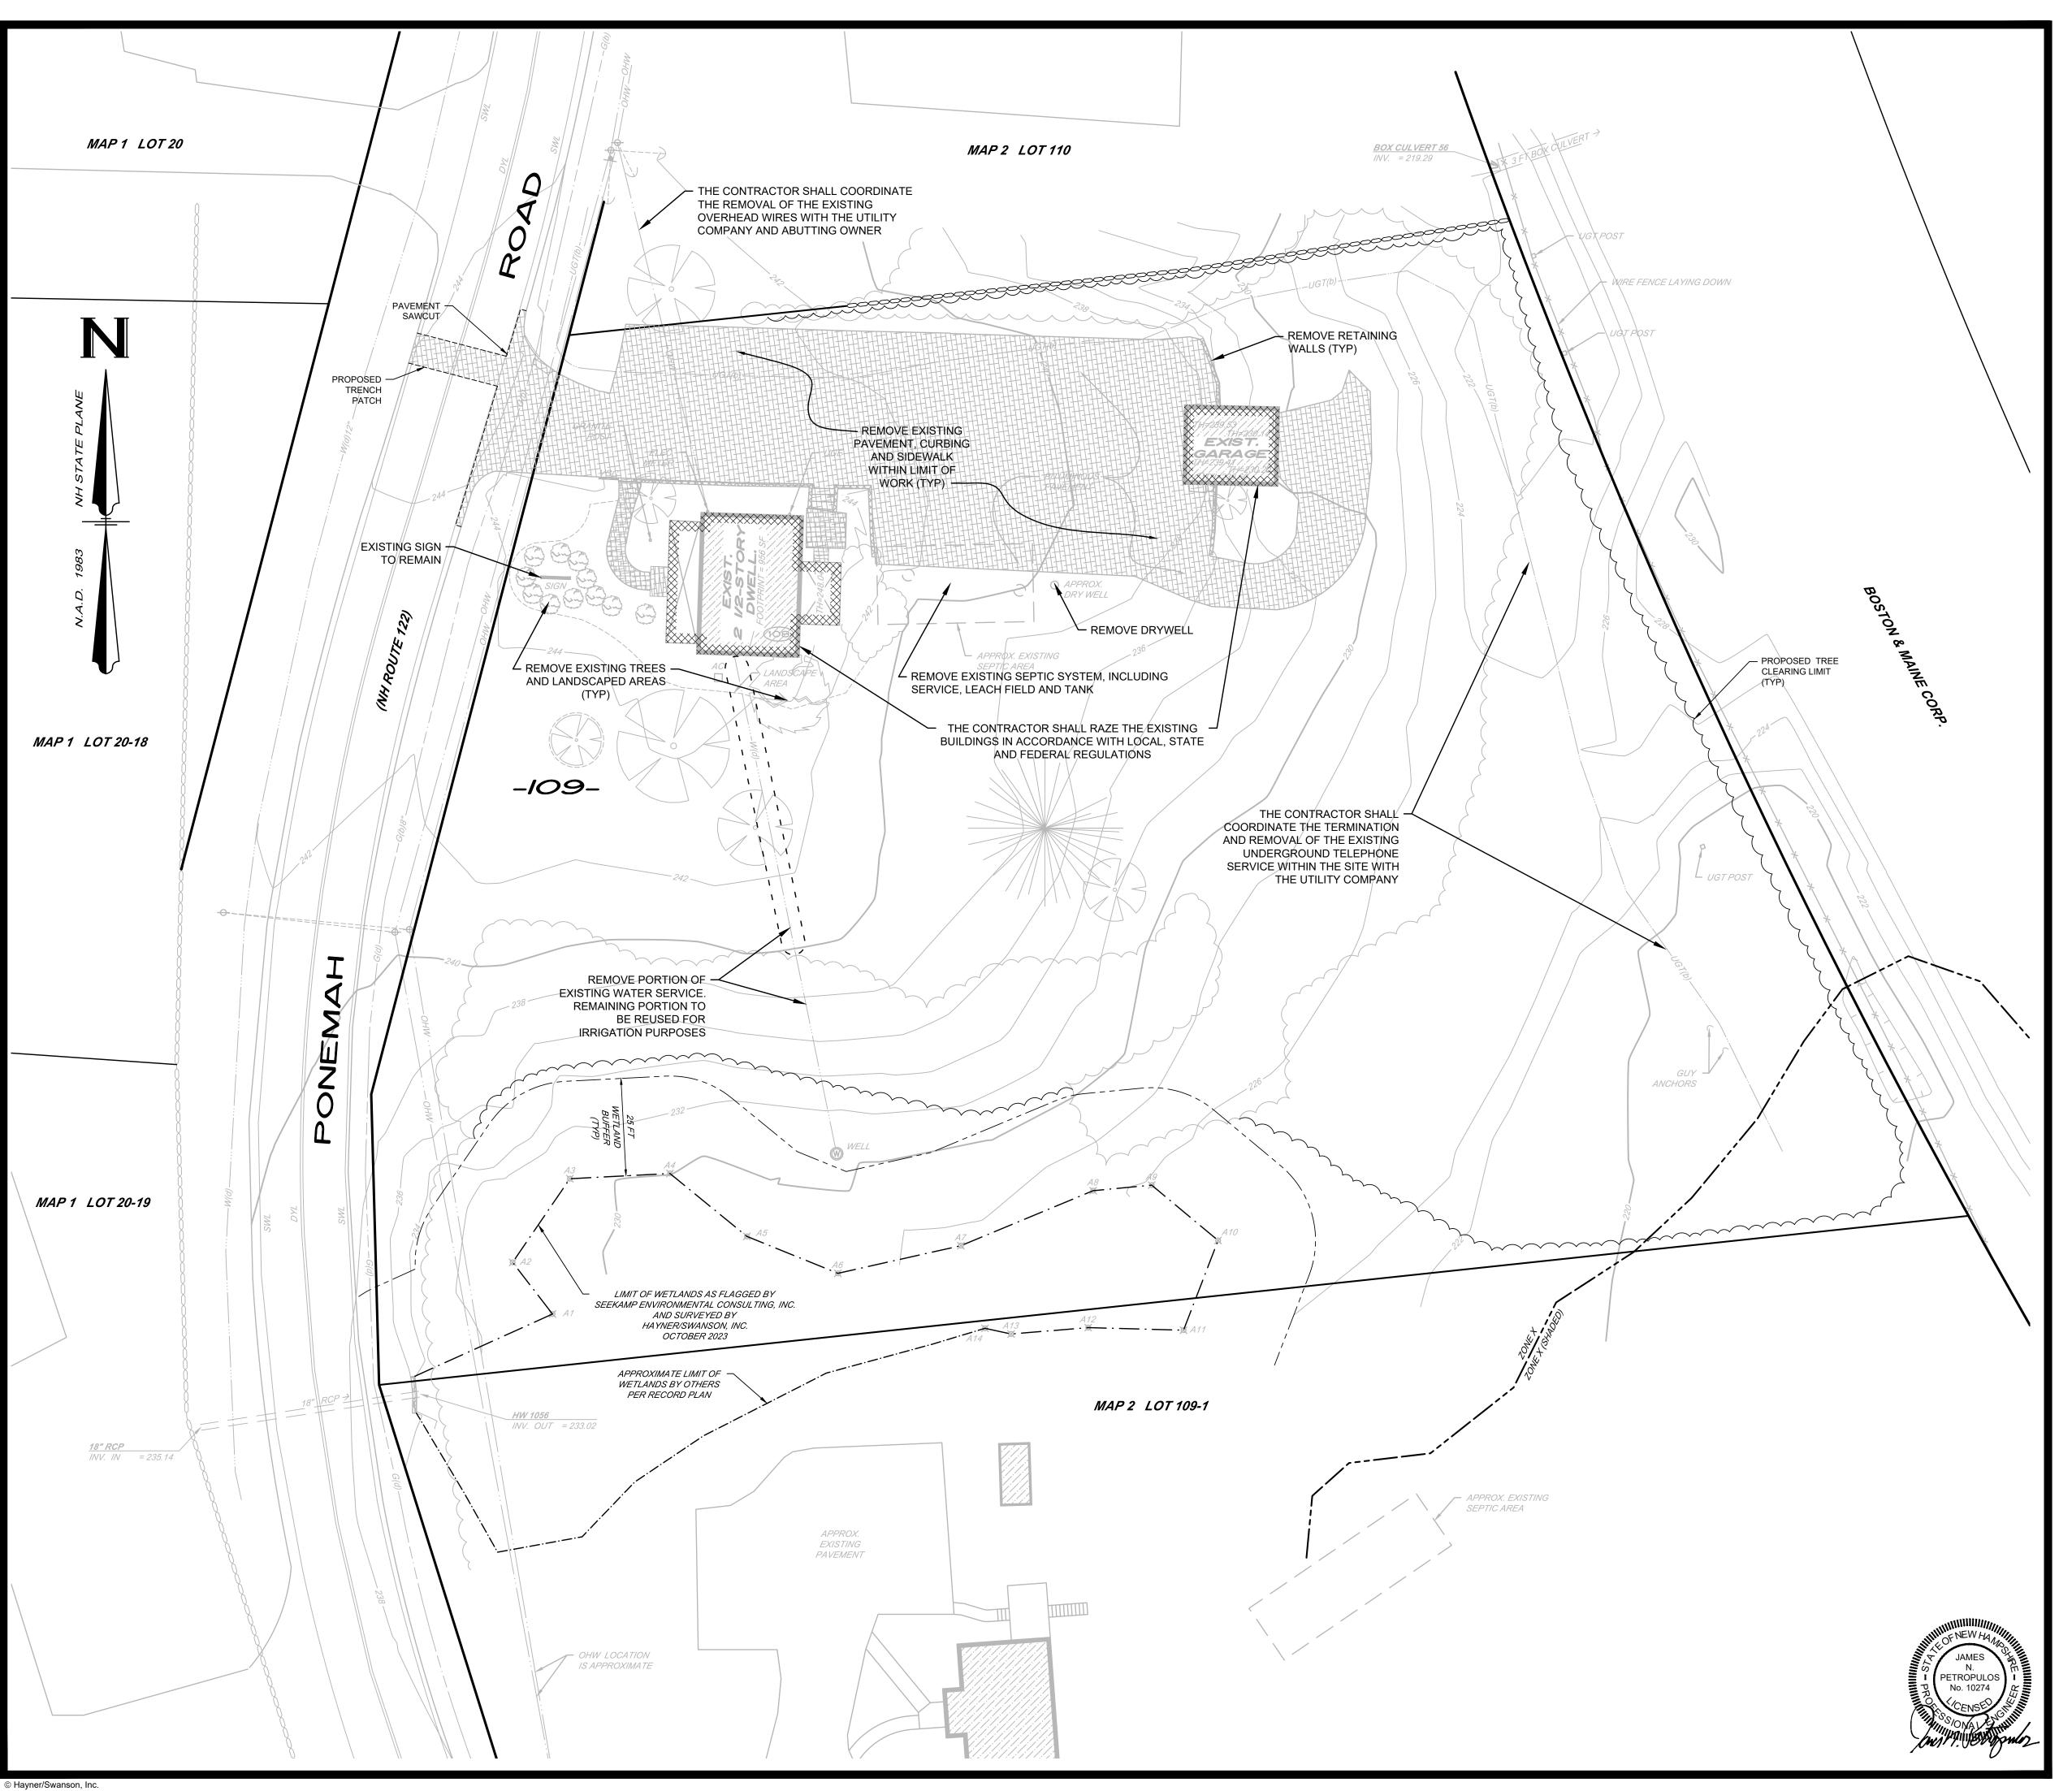- THE CONTRACTOR IS RESPONSIBLE FOR THE DEMOLITION, REMOVAL, AND DISPOSING IN A LOCATION APPROVED BY ALL GOVERNING AUTHORITIES, OF ALL STRUCTURES, PADS, WALLS, FENCES. FOUNDATIONS, PARKING, DRIVES, DRAINAGE, STRUCTURES, UTILITIES, ETC., SUCH THAT THE IMPROVEMENTS SHOWN ON THE REMAINING PLANS CAN BE CONSTRUCTED. ALL FACILITIES TO BE REMOVED SHALL BE UNDERCUT TO SUITABLE MATERIAL AND BROUGHT TO GRADE WITH SUITABLE COMPACTED FILL MATERIAL PER THE ENGINEERS RECOMMENDATIONS.
- THE CONTRACTOR IS RESPONSIBLE FOR REMOVING ALL DEBRIS FROM THE SITE AND DISPOSING THE DEBRIS IN A LAWFUL MANNER. THE CONTRACTOR IS RESPONSIBLE FOR OBTAINING ALL PERMITS REQUIRED FOR DEMOLITION AND DISPOSAL.
- THE CONTRACTOR SHALL COORDINATE WITH RESPECTIVE UTILITY COMPANIES PRIOR TO THE REMOVAL AND/OR RELOCATION OF UTILITIES. THE CONTRACTOR SHALL COORDINATE WITH THE UTILITY COMPANY CONCERNING PORTIONS OF WORK WHICH MAY BE PERFORMED BY THE UTILITY COMPANY'S FORCES AND ANY FEES WHICH ARE TO BE PAID TO THE UTILITY COMPANY FOR THEIR SERVICES. THE CONTRACTOR IS RESPONSIBLE FOR PAYING ALL FEES AND CHARGES.
- THE LOCATIONS OF ALL EXISTING UTILITIES SHOWN ON THIS PLAN HAVE BEEN DETERMINED FROM THE BEST INFORMATION AVAILABLE AND ARE GIVEN FOR THE CONVENIENCE OF THE CONTRACTOR. THE ENGINEER ASSUMES NO RESPONSIBILITY FOR THEIR ACCURACY. PRIOR TO THE START OF ANY DEMOLITION ACTIVITY, THE CONTRACTOR SHALL NOTIFY THE UTILITY COMPANIES FOR ON SITE LOCATIONS OF EXISTING UTILITIES.
- EXISTING UTILITIES SHOWN ARE NOT TO BE INTERPRETED AS THE EXACT LOCATION, OR AS THE ONLY OBSTACLES THAT MAY OCCUR ON THE SITE. VERIFY EXISTING CONDITIONS AND PROCEED WITH CAUTION AROUND ANY ANTICIPATED FEATURES. GIVE NOTICE TO ALL UTILITY COMPANIES REGARDING DESTRUCTION AND REMOVAL OF ALL SERVICE LINES AND CAP ALL LINES BEFORE PROCEEDING WITH
- ELECTRICAL, TELEPHONE, CABLE, WATER, FIBERGLASS PIPE (HEAT), FIBER OPTIC CABLE AND/OR GAS LINES NEEDING TO BE REMOVED OR RELOCATED SHALL BE COORDINATED WITH THE AFFECTED UTILITY COMPANY. ADEQUATE TIME SHALL BE PROVIDED FOR RELOCATION AND CLOSE COORDINATION WITH THE UTILITY COMPANY IS NECESSARY TO PROVIDE A SMOOTH TRANSITION IN UTILITY SERVICE. CONTRACTOR SHALL PAY CLOSE ATTENTION TO EXISTING UTILITIES WITHIN THE ANY ROAD RIGHT OF WAY DURING CONSTRUCTION.
- PRIOR TO SITE DEMOLITION ACTIVITIES, ALL APPROPRIATE EROSION CONTROL MEASURES SHALL BE INSTALLED, INCLUDING PERIMETER CONTROLS.
- THE CONTRACTOR SHALL BE RESPONSIBLE FOR NOTIFYING THE TOWN OF AMHERST COMMUNITY DEVELOPMENT/BUILDING DEPARTMENT PRIOR TO THE START OF CONSTRUCTION. A DEMOLITION PERMIT SHALL BE OBTAINED FROM THE TOWN PRIOR TO THE COMMENCEMENT OF WORK.



**PRELIMINARY** No. DATE REVISION

SITE DEMOLITION PLAN (MAP 2, LOT 109)

108 PONEMAH ROAD AMHERST, NEW HAMPSHIRE

PREPARED FOR/RECORD OWNER:

AZ REALTY, LLC 12 GILBOA LANE NASHUA, NEW HAMPSHIRE 03062


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DRAWING NAME: 5934-SITE-DM21 FIELD BOOK: 1276 DRAWING LOC: J: \5000\5934\DWG\5934 SITE

5934-SITE 3 OF 16



# **TOWN OF AMHERST** CONTACTS

#### **COMMUNITY DEVELOPMENT DEPARTMENT:**

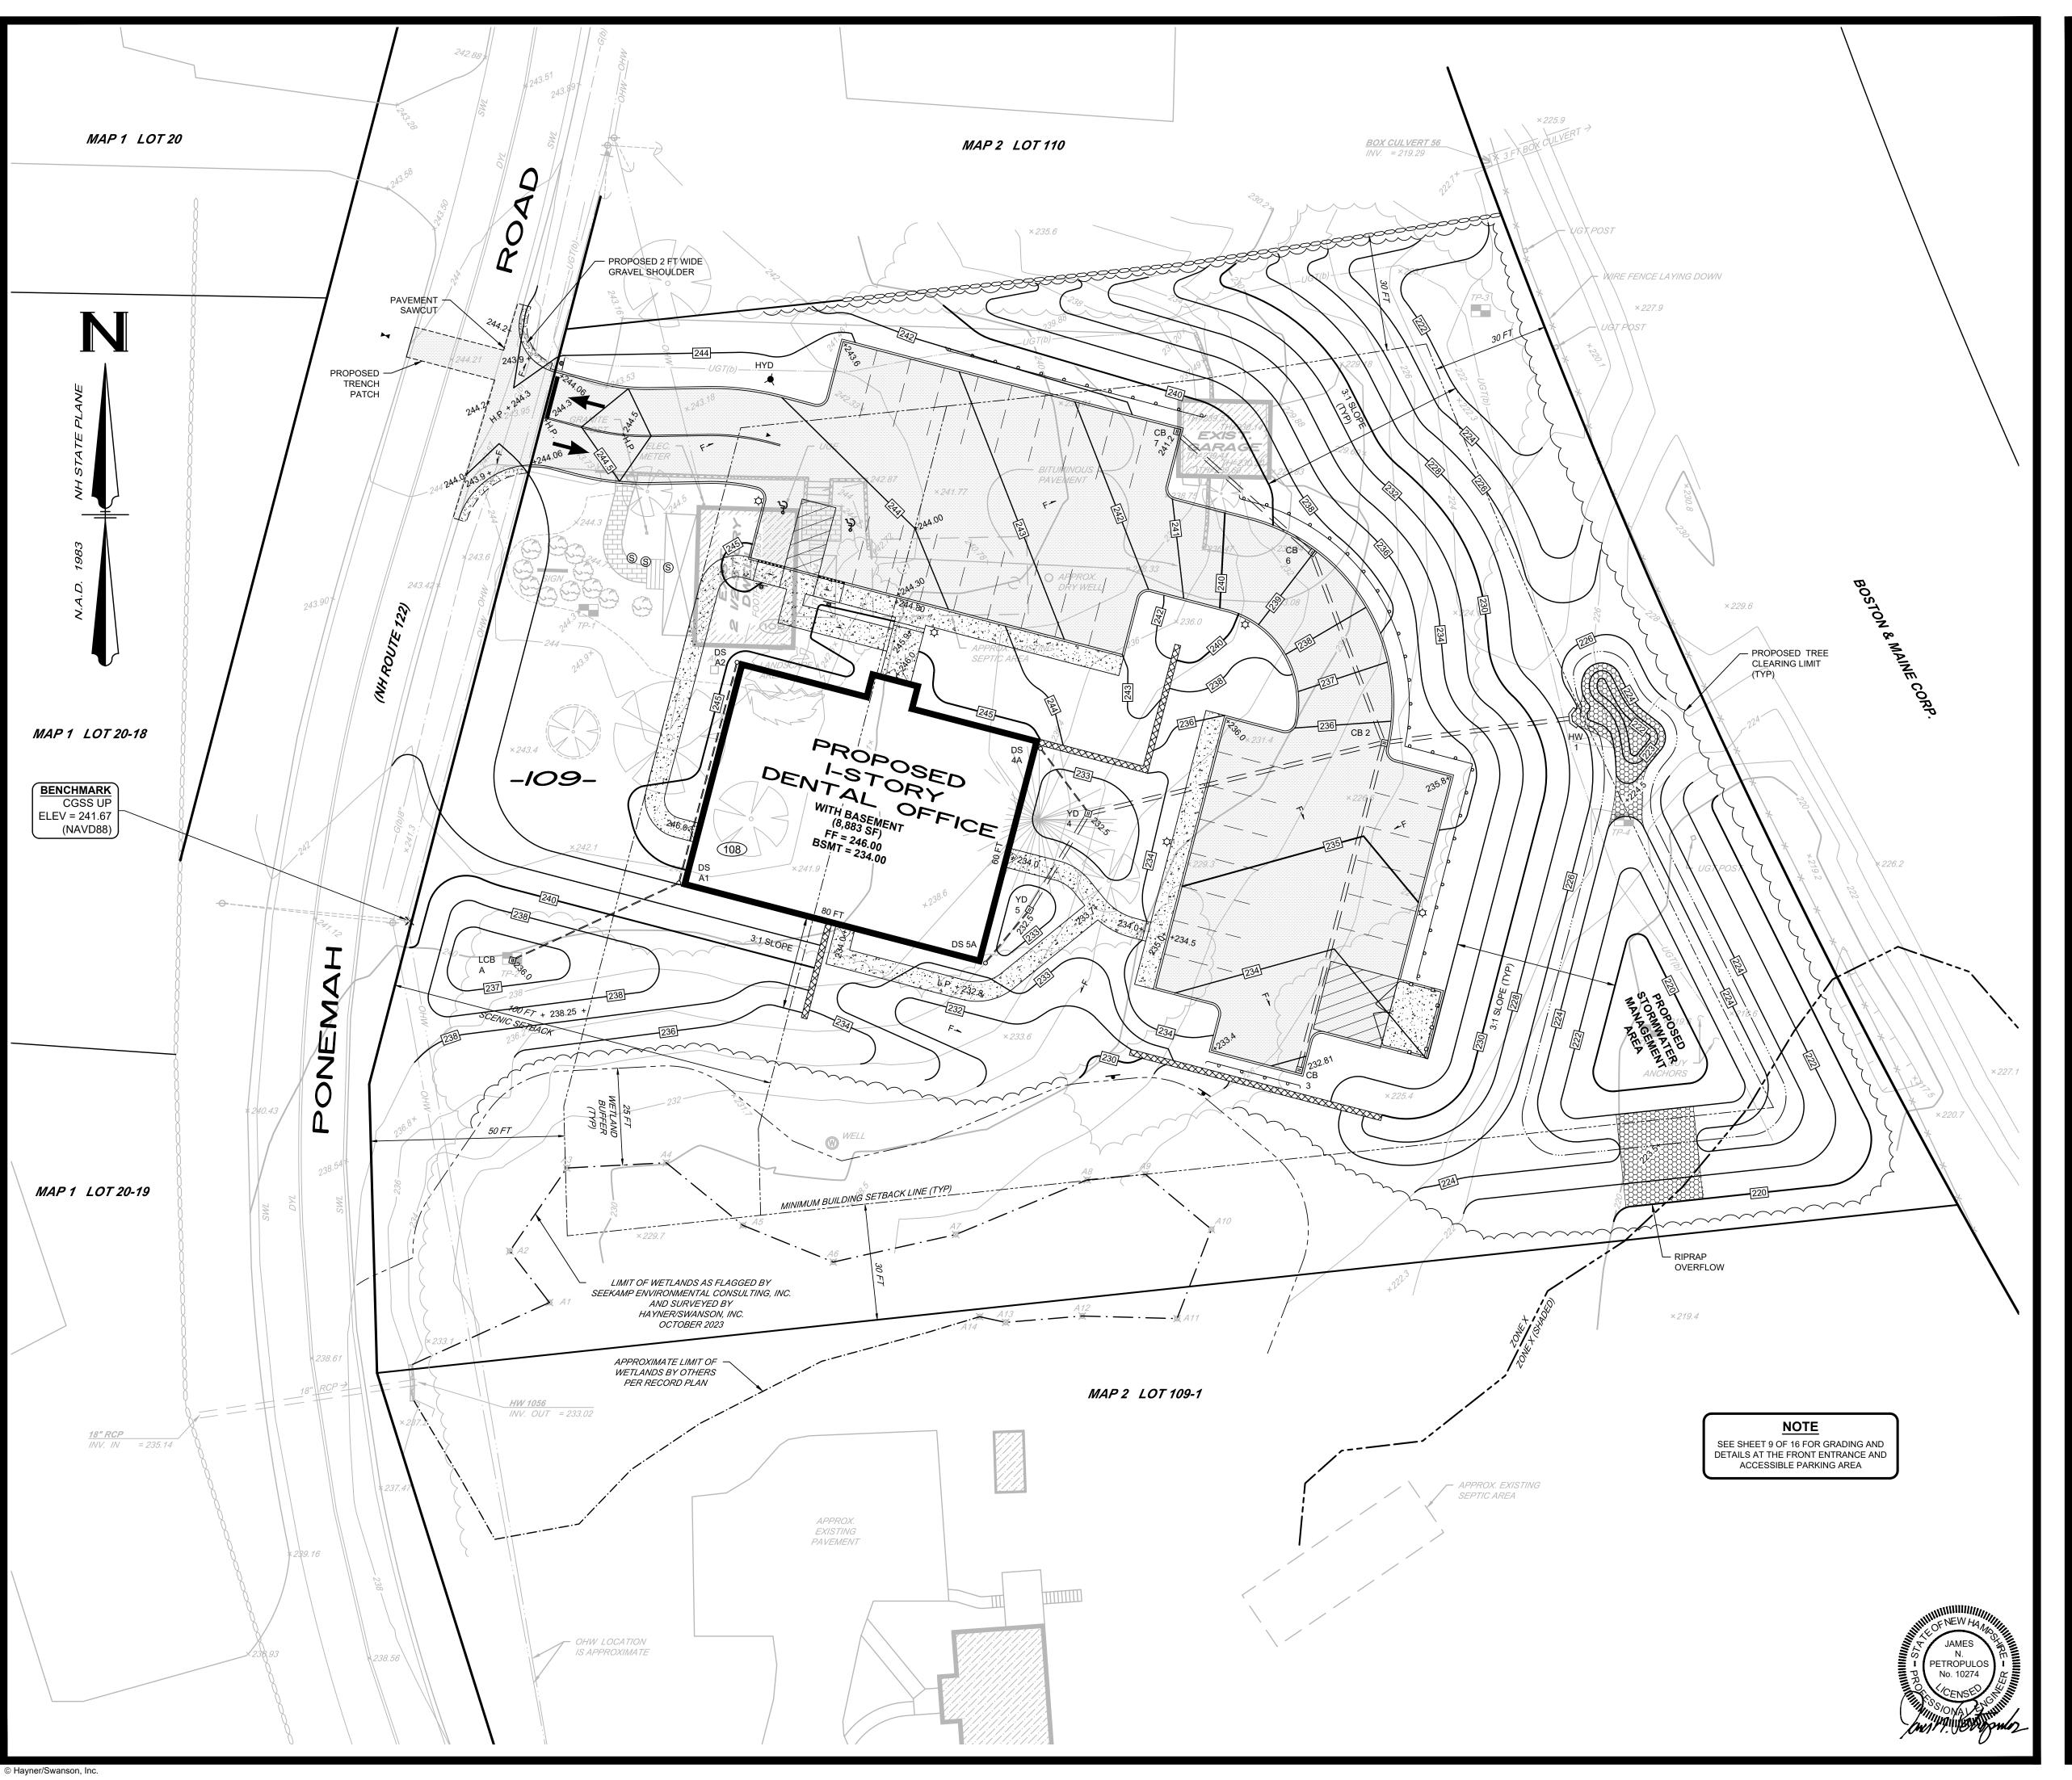2 MAIN STREET

AMHERST, NH 03031

(603) 673-6041 X 204 **DEPARTMENT OF PUBLIC WORKS** 

ATT: NICOLA STRONG

22 DODGE ROAD AMHERST, NH 03031

ATT: ERIC SLOSEK (603) 673-6041, EX 404

#### FIRE DEPARTMENT: 177 AMHERST STREET

AMHERST, NH 03031

(603) 673-6041, EX 214

ATT: MATTHEW CONLEY (603) 673-1545 X 301

#### BUILDING DEPARTMENT/HEALTH OFFICER: 2 MAIN STREET

AMHERST, NH 03031

ATT: SCOTT TENNEY

PENNICHUCK WATER WORKS 25 MANCHESTER STREET MERRIMACK, NH 03054

ATT: JOHN BOISVERT, PE

(603) 913-2300

**UTILITY CONTACTS** 

LIBERTY UTILITIES 11 NORTHEASTERN BLVD. SALEM, NH 03079

#### ATT: RYAN LAGASSE (603) 327-7151

TELEPHONE: CONSOLIDATED COMMUNICATIONS 257 DANIEL WEBSTER HWY.

#### MERRIMACK, NH 03054 ATT: JOY MENDONCA

(603) 645-2713

POWER: **EVERSOURCE** 370 AMHERST STREET NASHUA, NH 03060

> ATT: MARC GAGNON (603) 882-5894

### **CONSTRUCTION NOTES:**

- ALL WORK SHALL CONFORM TO THE APPLICABLE REGULATIONS AND STANDARDS OF THE TOWN OF AMHERST AND SHALL BE BUILT IN A WORKMANLIKE MANNER IN ACCORDANCE WITH THE PLANS AND
- ROAD AND DRAINAGE CONSTRUCTION SHALL CONFORM TO THE TYPICAL SECTIONS AND DETAILS SHOWN ON THE PLANS, AND SHALL MEET THE REQUIREMENTS AND SPECIFICATIONS FOR ROAD CONSTRUCTION BY THE TOWN OF AMHERST DEPARTMENT OF PUBLIC WORKS.
- THE CONTRACTOR SHALL BE RESPONSIBLE FOR VERIFYING AND DETERMINING THE LOCATION, SIZE AND ELEVATION OF ALL EXISTING UTILITIES, SHOWN OR NOT SHOWN ON THESE PLANS, PRIOR TO THE START OF ANY CONSTRUCTION. THE ENGINEER SHALL BE NOTIFIED IN WRITING OF ANY UTILITIES FOUND INTERFERING WITH THE PROPOSED CONSTRUCTION, AND APPROPRIATE REMEDIAL ACTION TAKEN BEFORE PROCEEDING WITH THE WORK. THE CONTRACTOR SHALL BE RESPONSIBLE FOR CONTACTING "DIG SAFE" AT 1-888-344-7233 AT LEAST 72 HOURS BEFORE DIGGING.
- BLASTING, IF NEEDED, SHALL BE PERFORMED IN ACCORDANCE WITH THE TOWN OF AMHERST FIRE DEPARTMENT REGULATIONS.
- ALL STUMPS SHALL BE DISPOSED OF OFF-SITE IN A LEGAL MANNER.
- ALL DISTURBED AREAS SHALL BE LOAMED AND SEEDED IMMEDIATELY UPON BEING CONSTRUCTED.
- PRIOR TO COMMENCEMENT OF MAJOR CONSTRUCTION ACTIVITIES, THE ENGINEER SHALL PROVIDE THE CONTRACTOR WITH LAYOUT PLANS AND COORDINATE VALUES FOR STRATEGIC ELEMENTS OF THE SITE.
- THE CONTRACTOR SHALL REFER TO THE ARCHITECTURAL PLANS FOR THE EXACT BUILDING DIMENSIONS AND DETAILS.
- ALL DIMENSIONS ARE FROM FACE OF CURB OR OUTSIDE FACE OF BUILDING UNLESS NOTED
- ALL SIGNAGE SHALL BE IN ACCORDANCE WITH THE MANUAL OF UNIFORM TRAFFIC CONTROL DEVICES (MUTCD), LATEST EDITION.



SITE GRADING & DRAINAGE PLAN (MAP 2, LOT 109)

# 108 PONEMAH ROAD

REVISION

AMHERST, NEW HAMPSHIRE

PREPARED FOR/RECORD OWNER:

No. DATE

FIELD BOOK: 1276

# AZ REALTY, LLC


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5934—SITE | 4 OF 16

DRAWING NAME: 5934-SITE-FG21 DRAWING LOC: J: \5000\5934\DWG\5934 SITE



# **UTILITY NOTES:**

- ALL DRAINAGE PIPE SHALL BE HDPE ADS N-12 SOILTIGHT (ST) PIPE AND JOINTS OR AN APPROVED EQUAL. MANUFACTURER'S INSTALLATION INSTRUCTIONS SHALL BE FOLLOWED.
- ALL WATER LINE, HYDRANT VALVES AND APPURTENANCES SHALL BE INSTALLED IN ACCORDANCE WITH THE PENNICHUCK WATER WORKS TECHNICAL SPECIFICATIONS FOR WATER MAIN, HYDRANT, AND SERVICE INSTALLATIONS (LATEST EDITION).
- THE SITE IS SERVICED BY AN EXISTING PRIVATE, SEPTIC SYSTEM.
  - ALL ELECTRIC RELATED WORK SHALL CONFORM TO EVERSOURCE STANDARDS.
- ALL TELECOMMUNICATIONS WORK SHALL CONFORM TO CONSOLIDATED COMMUNICATIONS
- ALL NATURAL GAS RELATED WORK SHALL COMPLY WITH LIBERTY UTILITIES STANDARDS.
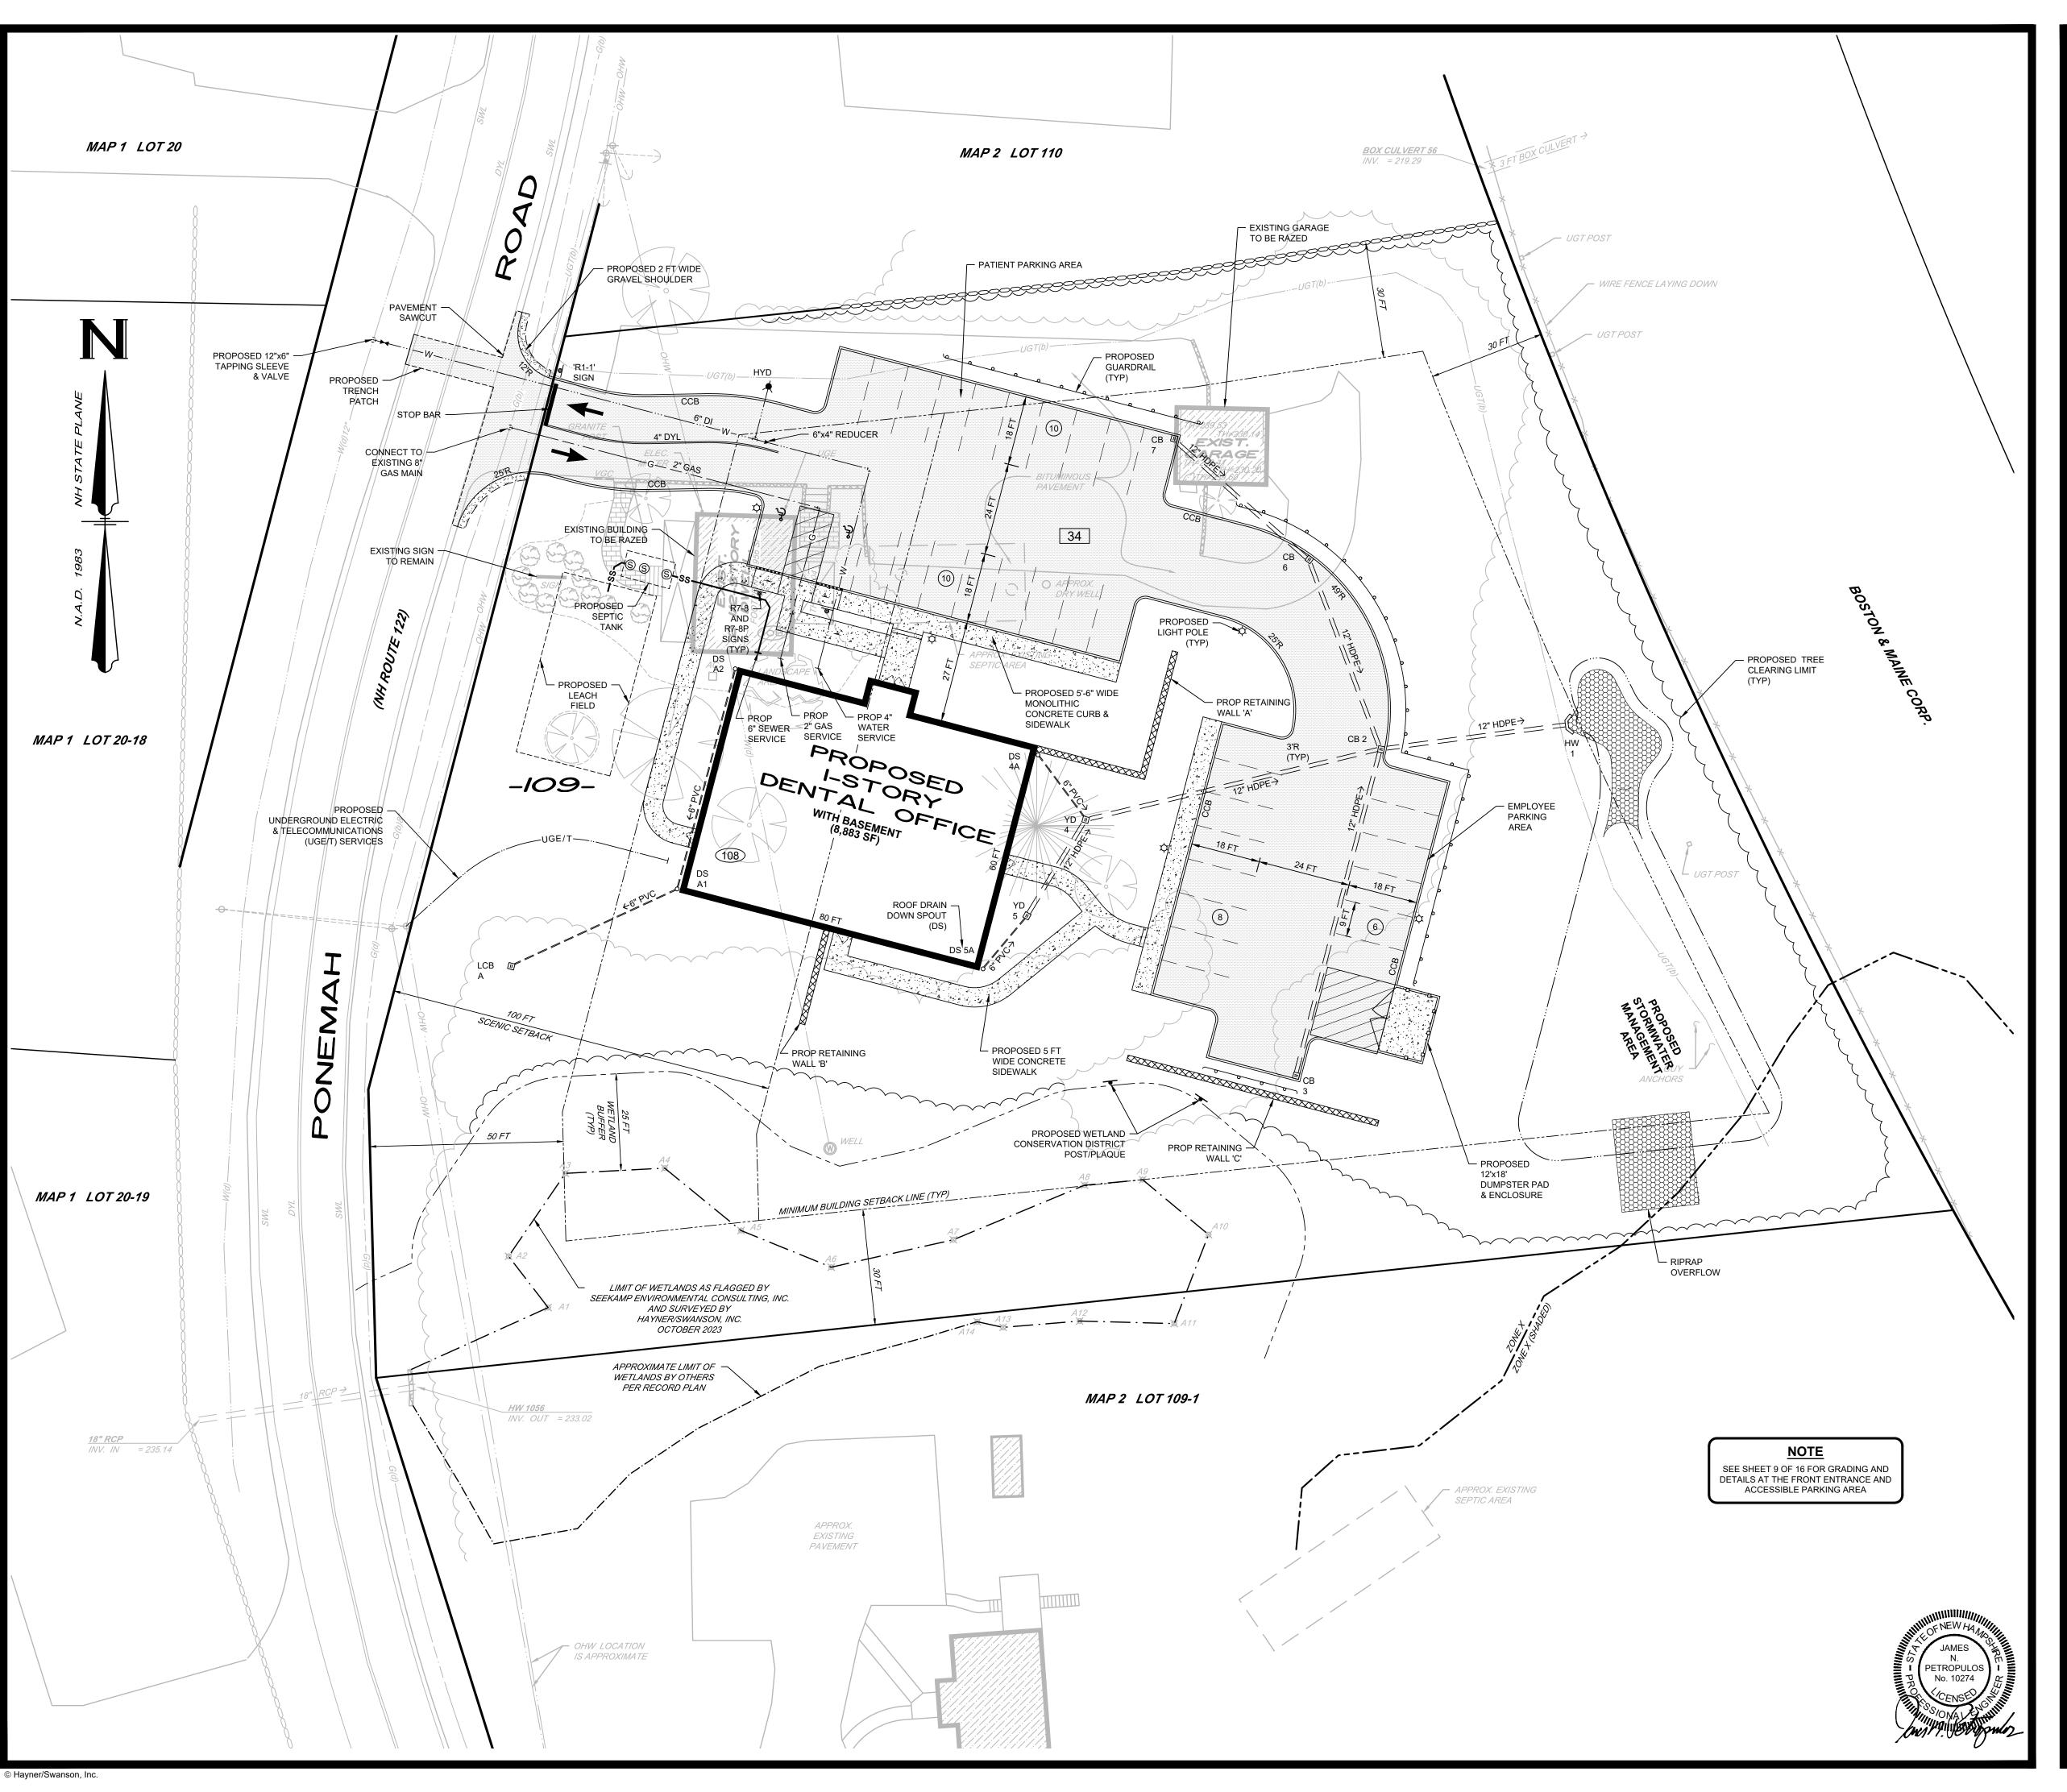
# **CURB, SIDEWALK & PAVEMENT** MARKING LEGEND

CAPE COD BERM

TIP DOWN CURB & SIDEWALK RAMP

CONCRETE CURB & SIDEWALK

DOUBLE YELLOW LINE

ACCESSIBLE PARKING SPACE IDENTIFIER

PAINTED ISLAND

18" STOP BAR

SIGN LEGEND IDENTIFICATION SIZE WIDTH/HEIGHT TEXT SEE MUTCD FOR TEXT TEXT DIMENSIONS DIMENSIONS 30"/30" SEE MANUAL ON UNIFORM TRAFFIC CONTROL DEVICES FOR STREETS AND HIGHWAYS RESERVED R7-8 12"/18" PARKING | SEE MANUAL ON UNIFORM TRAFFIC CONTROL DEVICES FOR STREETS AND 18"/9" VAN ACCESSIBLE



REVISION

SEE MANUAL ON UNIFORM TRAFFIC CONTROL DEVICES FOR STREETS AND

HIGHWAYS

SITE UTILITY & LAYOUT PLAN (MAP 2, LOT 109)

No. DATE

PROPOSED DENTAL OFFICE 108 PONEMAH ROAD AMHERST, NEW HAMPSHIRE

PREPARED FOR/RECORD OWNER:

AZ REALTY, LLC 12 GILBOA LANE NASHUA, NEW HAMPSHIRE 03062

> SCALE: 1"=20 Feet

> > I APRIL 2024





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DRAWING NAME: 5934-SITE-FQ21 FIELD BOOK: 1276 DRAWING LOC: J: \5000\5934\DWG\5934 SITE

5934—SITE | 5 OF 16



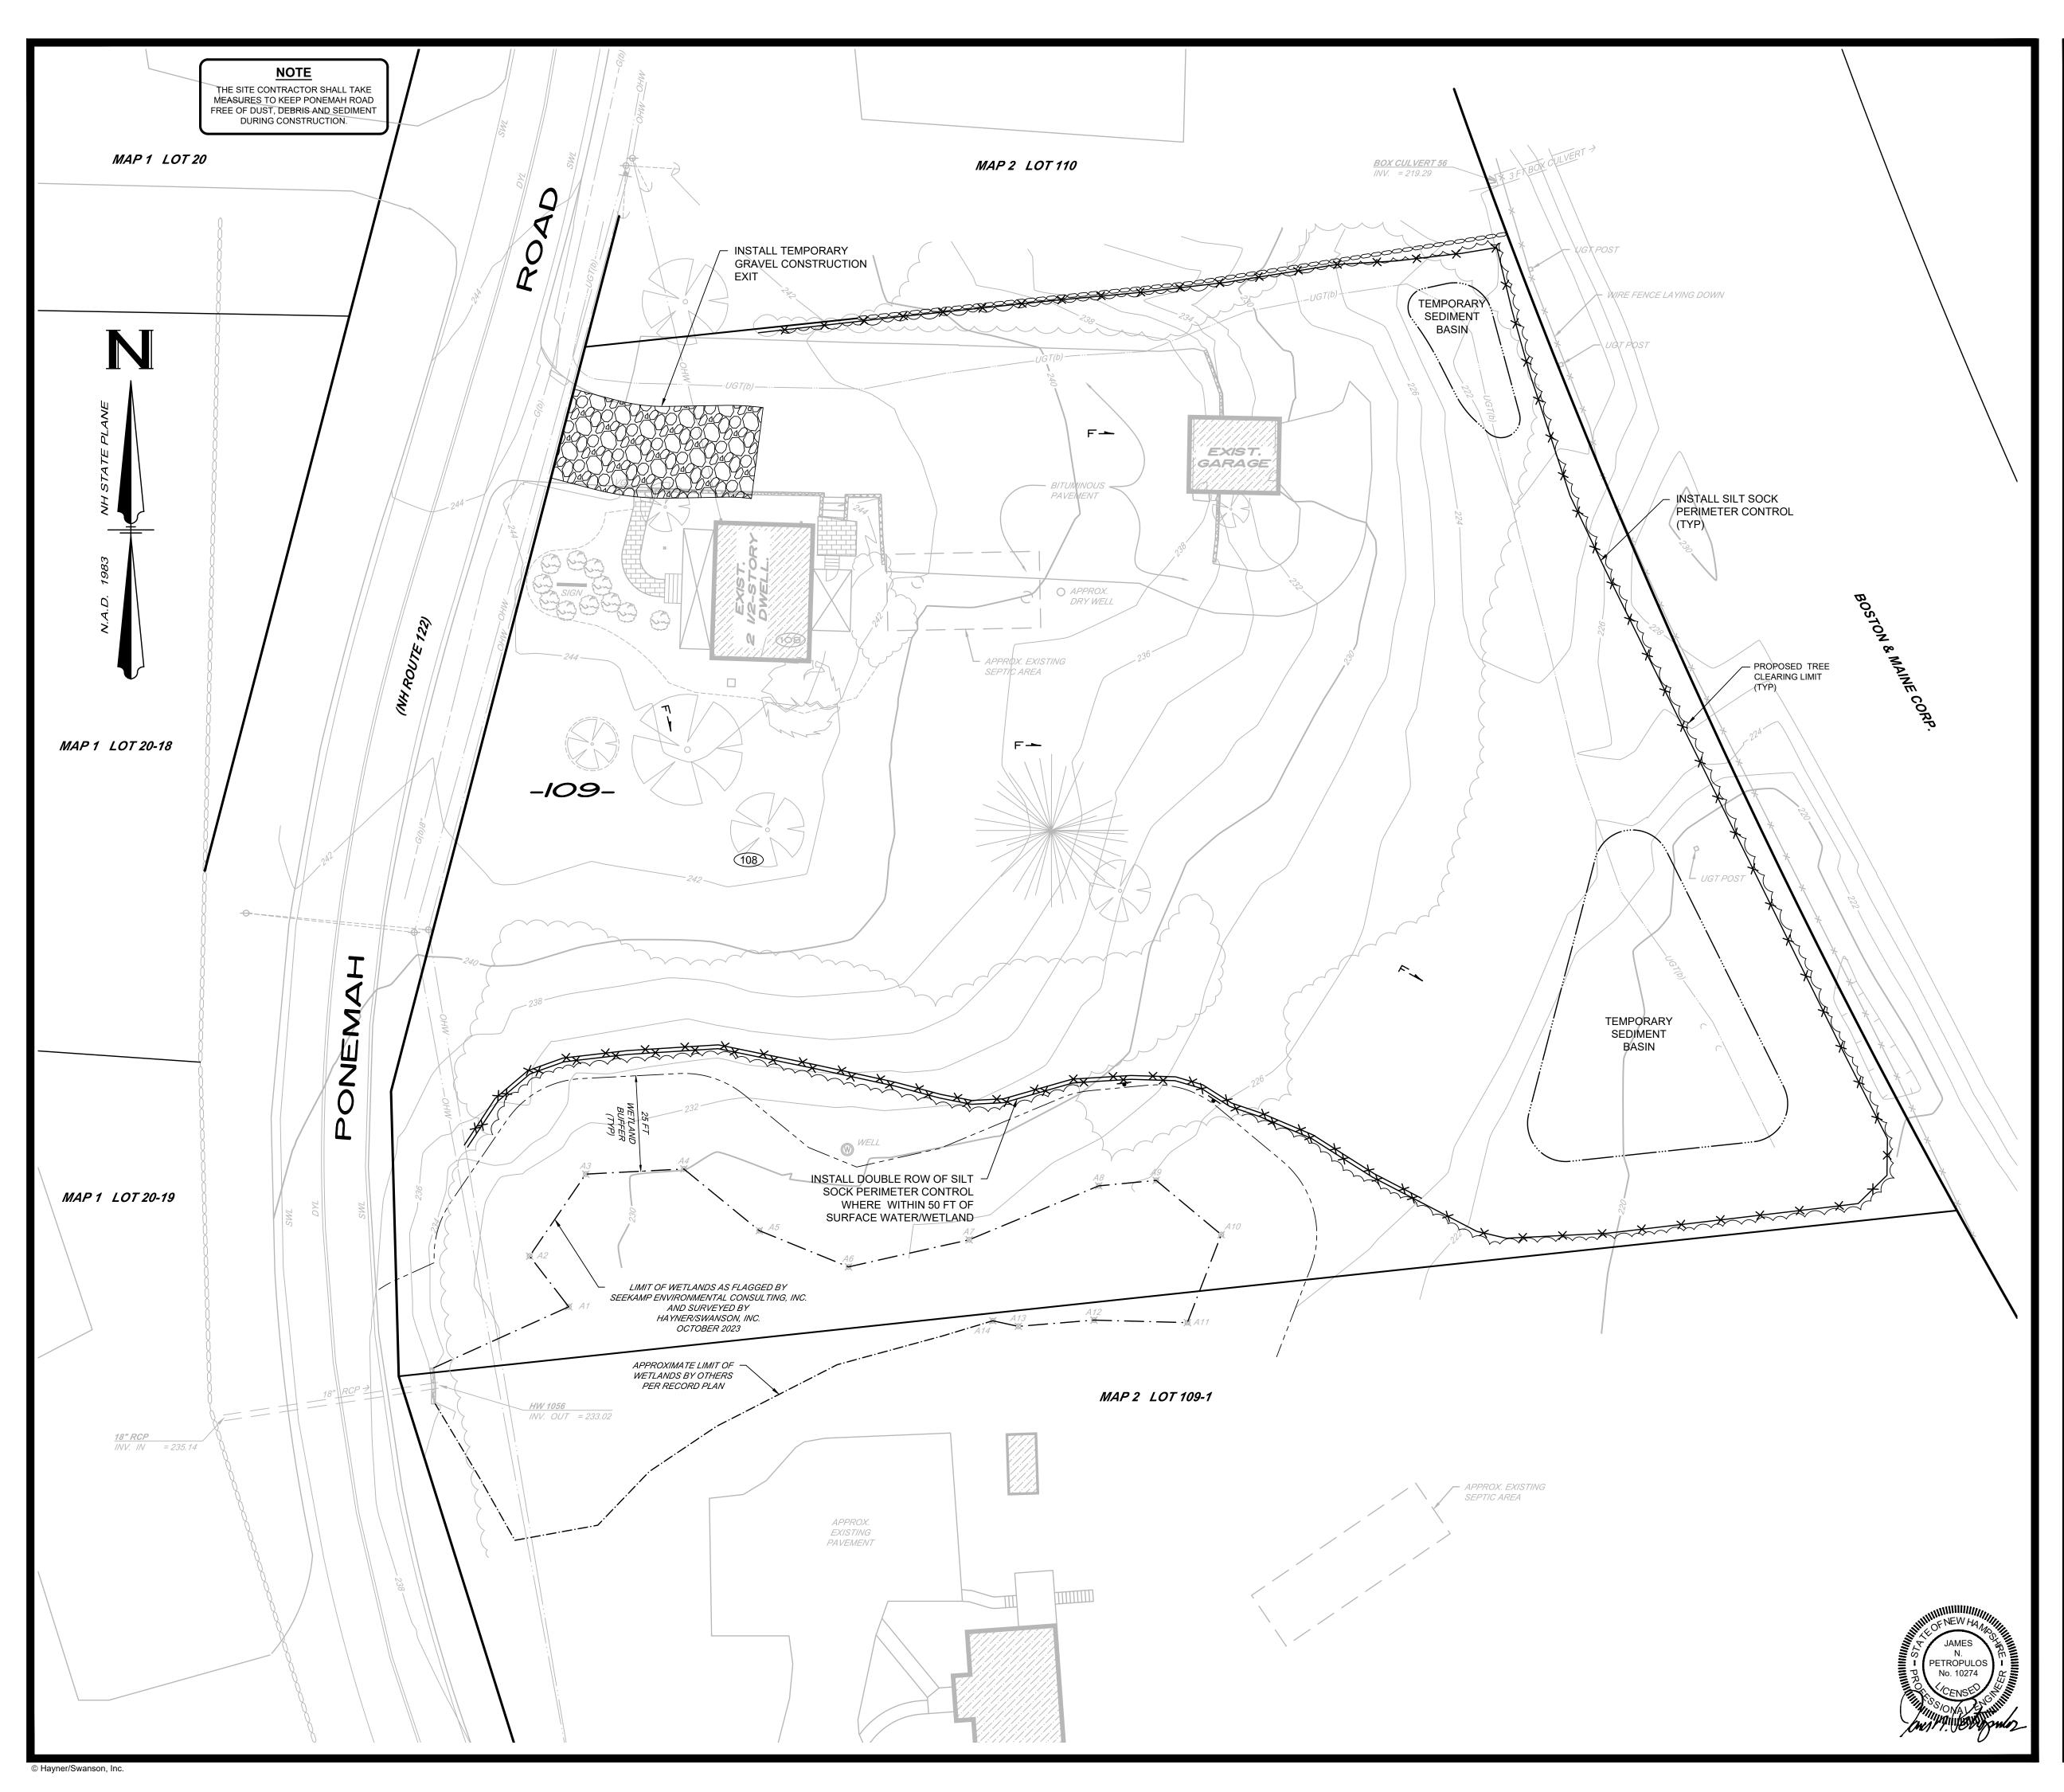

# **GENERAL NOTES:**

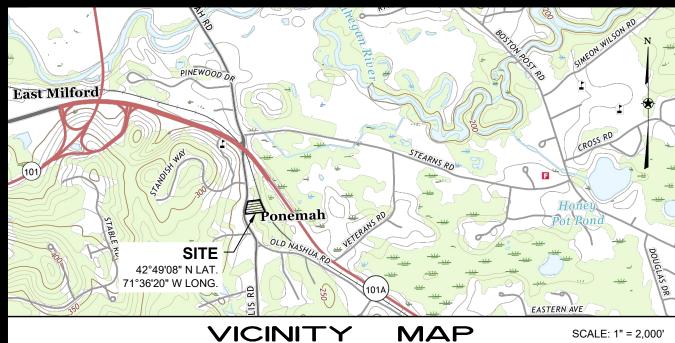- THE CONTRACTOR SHALL IMPLEMENT BEST MANAGEMENT PRACTICES AS REQUIRED BY THE SWPPP. ADDITIONAL BEST MANAGEMENT PRACTICES SHALL BE IMPLEMENTED AS DICTATED BY SITE CONDITIONS AT NO ADDITIONAL COST OF OWNER THROUGHOUT ALL PHASES OF
- BEST MANAGEMENT PRACTICES (BMP'S) AND CONTROLS SHALL CONFORM TO FEDERAL, STATE, OR LOCAL REQUIREMENTS OR MANUAL OF PRACTICE, AS APPLICABLE. CONTRACTOR SHALL IMPLEMENT ADDITIONAL CONTROLS AS DIRECTED BY PERMITTING AGENCY OR OWNER.
- ALL MEASURES STATED ON THIS EROSION CONTROL PLAN, SHALL BE MAINTAINED IN FULLY FUNCTIONAL CONDITION UNTIL NO LONGER REQUIRED FOR A COMPLETE PHASE OF WORK OR FINAL STABILIZATION OF THE SITE. ALL EROSION CONTROL MEASURES SHALL BE CHECKED BY A QUALIFIED PERSON IN ACCORDANCE WITH THE CONTRACT DOCUMENTS OR THE APPLICABLE PERMIT, WHICHEVER IS MORE STRINGENT.
- SILT SOCK SHALL BE REPAIRED TO THEIR ORIGINAL CONDITIONS IF DAMAGED. SEDIMENT SHALL BE REMOVED FROM SILT SOCK WHEN IT REACHED ONE-HALF THE HEIGHT OF THE BARRIER.
- 5. INLET PROTECTION DEVICES AND BARRIERS SHALL BE REPAIRED OR REPLACED IF THEY SHOW SIGNS OF UNDERMINING OR DETERIORATION.
- ALL SEEDED AREAS SHALL BE CHECKED REGULARLY TO SEE THAT A GOOD STAND IS MAINTAINED.
- AREAS SHOULD BE FERTILIZED, WATERED AND RESEEDED AS NEEDED.

  THE CONSTRUCTION EXITS SHALL BE MAINTAINED IN A CONDITION WHICH WILL PREVENT TRACKING OR FLOW OF SEDIMENT AND DEBRIS ONTO THE PUBLIC RIGHT-OF WAY. THIS MAY

REQUIRE PERIODIC TOP DRESSING OF THE CONSTRUCTION EXIT AS CONDITIONS DEMAND.

# **CONSTRUCTION SEQUENCE (PHASE 1):**

- 1. CONSTRUCT TEMPORARY CONSTRUCTION EXITS AND INSTALL SILT SOCK PERIMETER BARRIERS AS SHOWN ON THE PLAN.
- 2. PREPARE TEMPORARY STAGING/ STOCKPILE AREAS, AS NEEDED.
- 3. CLEAN & GRUB SITE ACCORDING TO PLAN. CUT AND DISPOSE OF ANY DEBRIS PRODUCED DURING THE CLEARING AND GRUBBING ACTIVITY.
- CONSTRUCT TEMPORARY SEDIMENT BASINS. BASINS SHALL BE STABILIZED PRIOR TO DIRECTING
- RUNOFF TO THEM.
- 5. PERFORM BUILDING AND SITE DEMOLITION.
- PERFORM SITE GRADING OF BUILDING PAD AND PARKING AREAS. ALL SLOPES SHALL BE LOAMED AND SEEDED WITHIN 72 HOURS OF ACHIEVING FINISH GRADE. STABILIZATION MATTING SHALL BE INSTALLED AT SLOPES 3:1 OR STEEPER OR AS SHOWN ON THE PLANS.

# LEGEND

EXISTING GROUND CONTOUR
 PROPOSED GRADE
 WETLAND FLAGGING LIMIT
 RUNOFF DIRECTION
 SILT SOCK

ORANGE CONSTRUCTION FENCE

SILT-SACK INLET PROTECTION DEVICES

GRAVEL CONSTRUCTION EXIT

STABILIZATION MATTING

TEMPORARY STONE CHECK DAM

LIMIT OF WORK

PRELIMINARY
DESIGN REVIEW

EROSION CONTROL PLAN - PHASE I (MAP 2, LOT 109)

PKUPUJEU UENIAL UTTIGE 108 PONEMAH ROAD AMHERST, NEW HAMPSHIRE

PREPARED FOR/RECORD OWNER:

# AZ REALTY, LLC

I APRIL 2024

SCALE: 1"=20 Feet




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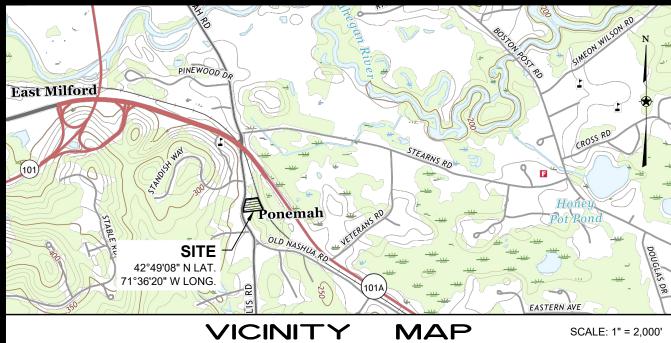
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FIELD BOOK: 1276 DRAWING NAME: 5934—SITE—ER21 593

FIELD BOOK: 1276 | DRAWING NAME: 5934-SITE-ER21 | 5934-SITE | 6 OF 16

DRAWING LOC: J: \5000\5934\DWG\5934 SITE | File Number | Sheet



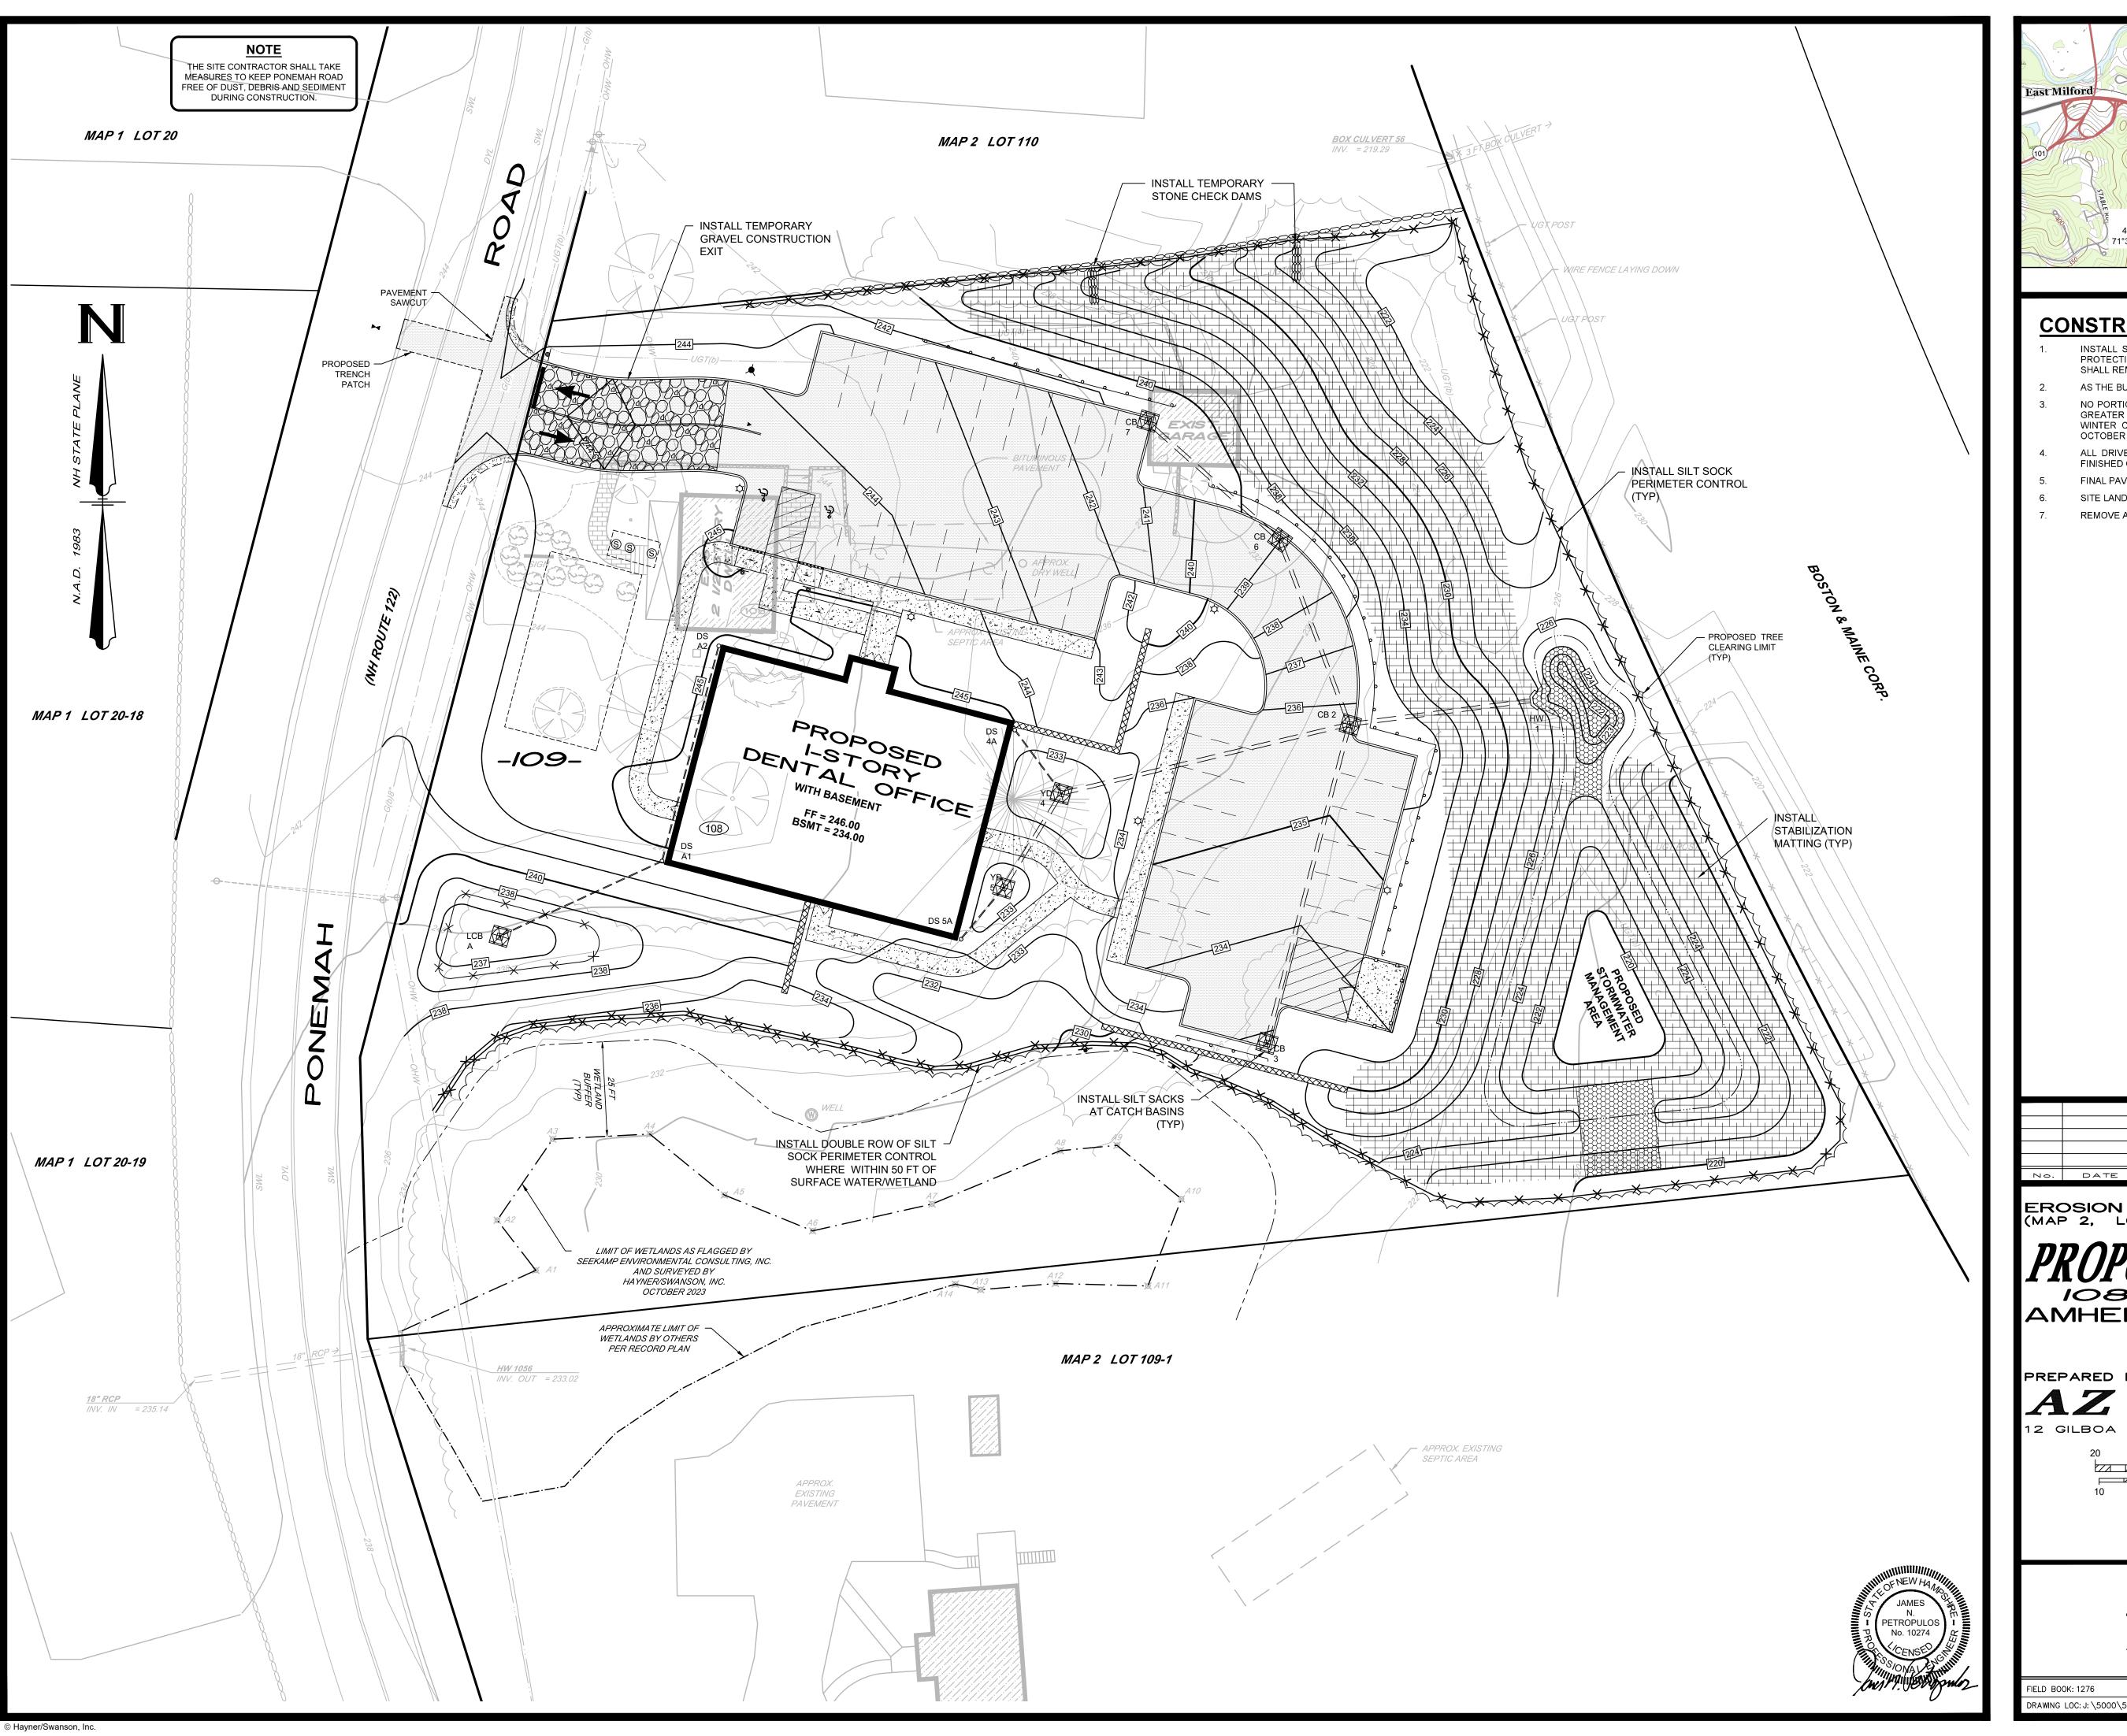

# **CONSTRUCTION SEQUENCE (PHASE 2)**

INSTALL SITE UTILITIES AND CONSTRUCT STORMWATER MANAGEMENT AREA. INSTALL INLET PROTECTION DEVICES AROUND ALL CATCH BASIN AND YARD DRAIN STRUCTURES. THE CONTROLS SHALL REMAIN UNTIL THE SITE IS SUFFICIENTLY STABILIZED.

- AS THE BUILDING IS COMPLETED, ALL DISTURBED AREAS SHALL BE PERMANENTLY STABILIZED.
- NO PORTION OF THE PROJECT SHALL BE LEFT DISTURBED AND UNSTABILIZED FOR A PERIOD OF GREATER THAN 45 DAYS. ALL DISTURBED AREAS SHALL BE PERMANENTLY STABILIZED PRIOR TO WINTER CONDITIONS. STABILIZATION SHALL BE DEFINED AS 85% VEGETATIVE GROWTH BY OCTOBER 15TH OR INSTALLATION OF EROSION CONTROL MATTING.
- ALL DRIVEWAYS AND PARKING LOTS SHALL BE STABILIZED WITHIN 72 HOURS OF ACHIEVING FINISHED GRADE.
- FINAL PAVING OF DRIVEWAYS AND PARKING LOTS.
- SITE LANDSCAPING ALONG WITH PERMANENT SEEDING OR ALL DISTURBED AREAS.
- REMOVE ANY TEMPORARY EROSION CONTROL MEASURES NOT NEEDED.

# **LEGEND**

EXISTING GROUND CONTOUR PROPOSED GRADE WETLAND FLAGGING LIMIT RUNOFF DIRECTION SILT SOCK ORANGE CONSTRUCTION FENCE SILT-SACK INLET PROTECTION DEVICES

GRAVEL CONSTRUCTION EXIT

STABILIZATION MATTING

TEMPORARY STONE CHECK DAM LIMIT OF WORK

**PRELIMINARY** 

EROSION CONTROL PLAN - PHASE 2 (MAP 2, LOT 109)

# 108 PONEMAH ROAD

REVISION

AMHERST, NEW HAMPSHIRE

PREPARED FOR/RECORD OWNER:

AZ REALTY, LLC

I APRIL 2024


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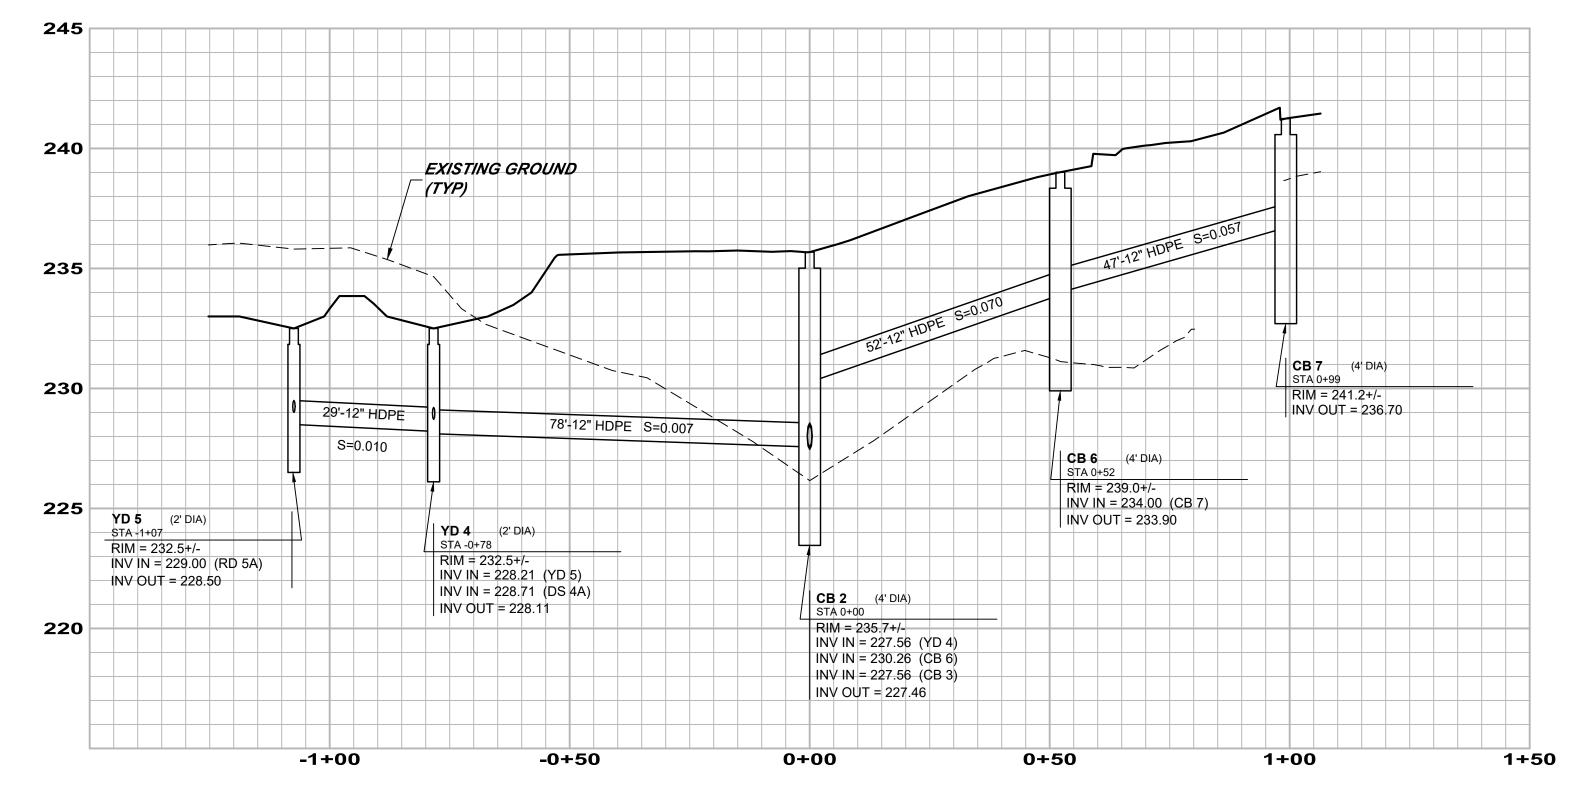
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5934-SITE 7 OF 16 DRAWING LOC: J: \5000\5934\DWG\5934 SITE



# STORMWATER MANAGEMENT AREA TO HW 1 TO CB 3



YD 5 TO CB 2 TO CB 7

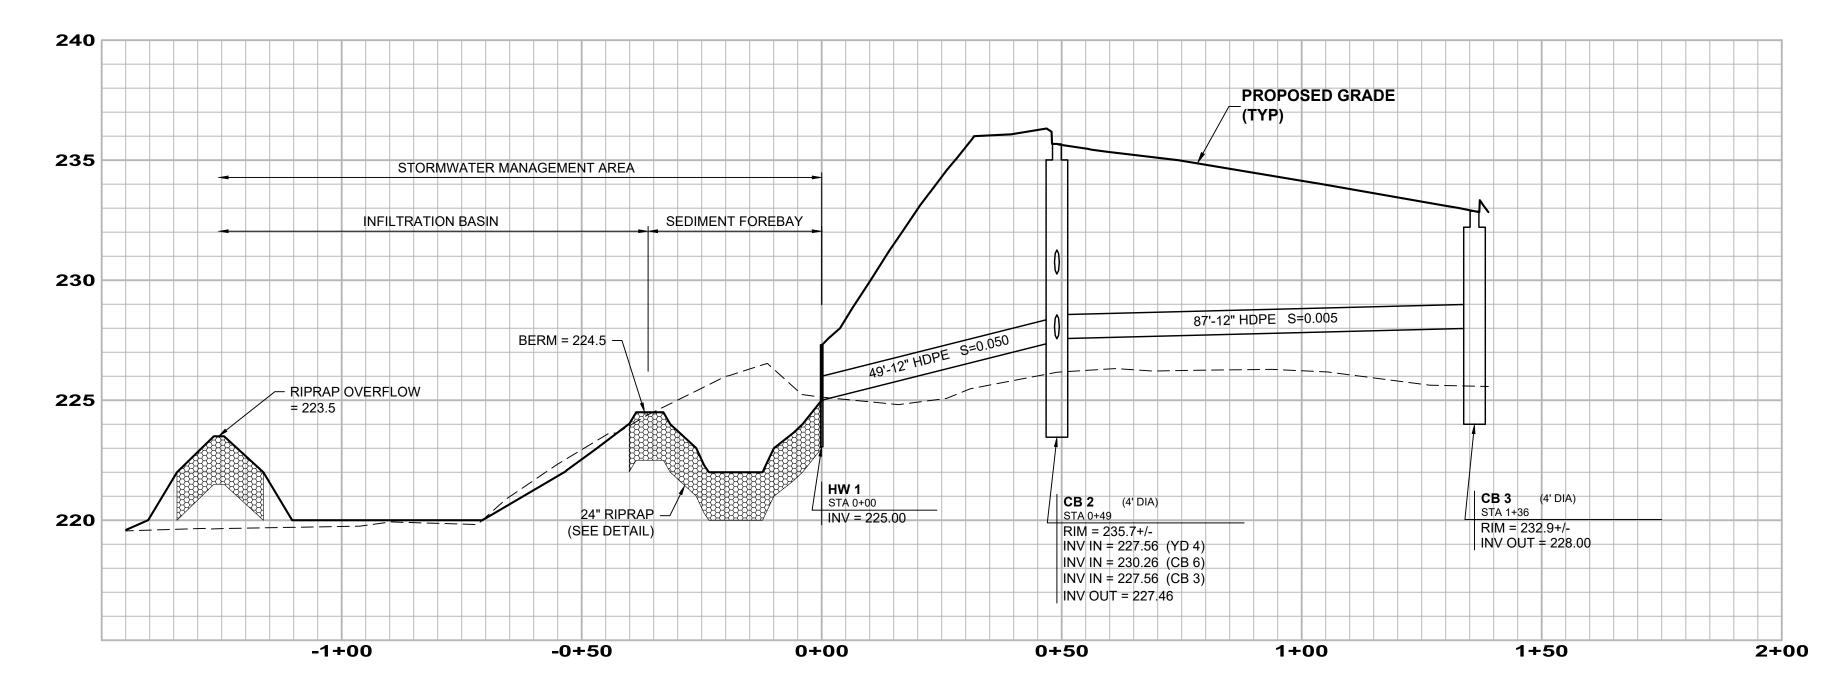

- STRUCTURE DIAMETERS AS SHOWN ON DRAINAGE PROFILES ARE CONSIDERED TO BE MINIMUM INSIDE DIMENSIONS, ALL STRUCTURES SHALL BE A MINIMUM INSIDE DIAMETER OF 48" UNLESS OTHERWISE INDICATED. LARGER STRUCTURES MAY BE NECESSARY DUE TO ALIGNMENT AND/OR PIPE SIZES. STRUCTURE MANUFACTURER
- SHALL DETERMINE FINAL SIZE. PIPE LENGTHS ARE MEASURED FROM CENTERLINE OF STRUCTURE TO CENTERLINE
- OF STRUCTURE.
- 3. EXTERIOR FOUNDATION WALLS AND FOOTINGS AS SHOWN ARE APPROXIMATE. 4. SEE PLUMBING PLANS FOR A DETAIL OF THE ROOF DRAIN PIPE/STORM DRAIN DROP

PRELIMINARY

CONNECTION.

UTILITY PROFILES (MAP 2, LOT 109)

No. DATE

PROPOSED DENTAL OFFICE 108 PONEMAH ROAD AMHERST, NEW HAMPSHIRE

REVISION

PREPARED FOR/RECORD OWNER:

AZ REALTY, LLC

12 GILBOA LANE NASHUA, NEW HAMPSHIRE 03062

SCALE: HORIZ. 1" = 20 Feet

VERT. 1" = 4 Feet

I APRIL 2024





Hayner/Swanson, Inc.

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Street 131 Middlesex Turnpike
4 03062 Burlington, MA 01803
3-2057 (781) 203-1501 3 Congress Street Nashua, NH 03062 (603) 883-2057 www.hayner-swanson.com


DRAWING NAME: 5934-SITE-FY21 FIELD BOOK: 1276 DRAWING LOC: J: \5000\5934\DWG\5934 SITE

5934-SITE 8 OF 16 File Number

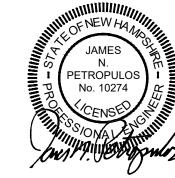


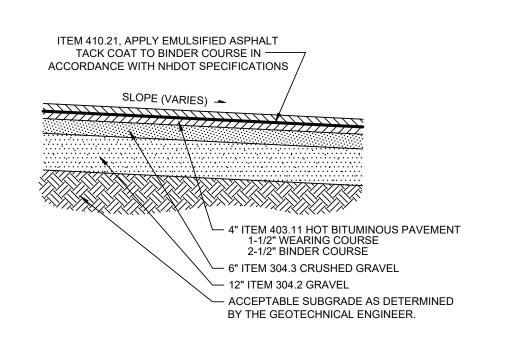

# **TYPICAL PAVEMENT SECTION**

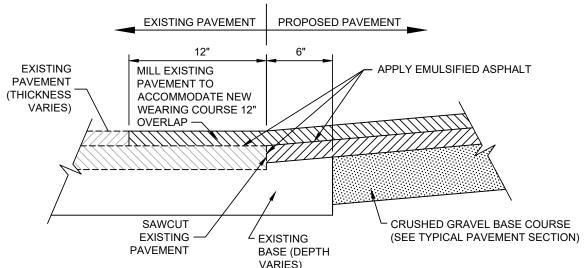


# SAWCUT PAVEMENT DETAIL

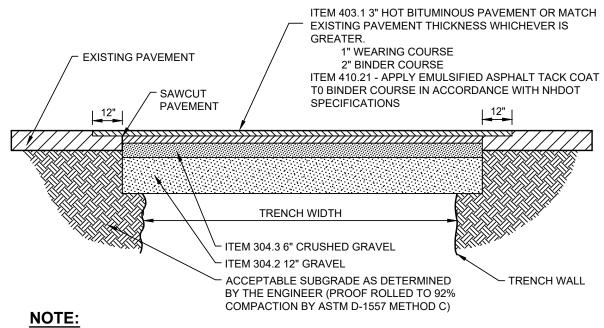


THE BINDER COURSE SHALL BE PLACED IMMEDIATELY AFTER THE TRENCH CONSTRUCTION, AND ALLOWED TO STAND FOR A MINIMUM OF 90 DAYS. A LEVELING COURSE SHALL BE APPLIED OVER THE TRENCH AFTER 90 DAYS AND THE AREA OVERLAYED TO THE LIMITS SHOWN ON THE PLANS.

BY THE GEOTECHNICAL ENGINEER


# TRENCH PATCH DETAIL

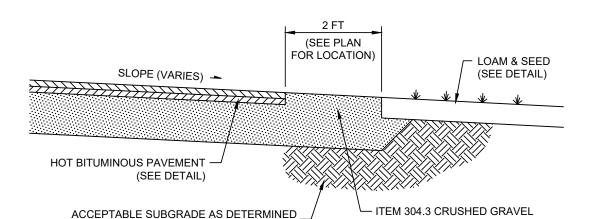


# **GRAVEL SHOULDER DETAIL**

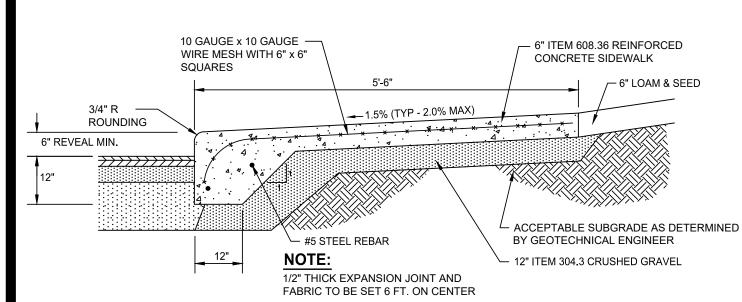

MONOLITHIC CONCRETE SIDEWALK AND CURB DETAIL

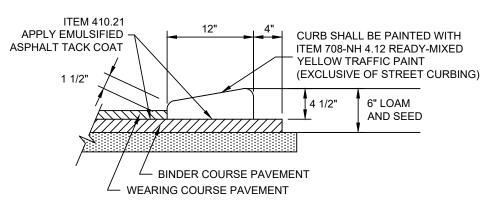

# CAPE COD BERM DETAIL

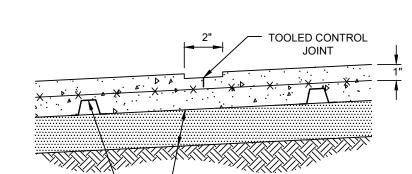


12" ITEM 304.3 CRUSHED GRAVEL

WIRE MESH SUPPORT (TYP) TO MAINTAIN MESH DEPTH, SPACING AND TO ELIMINATE SAG

THE CONTRACTOR SHALL PROVIDE TOOLED CONTROL JOINTS @ 5'-0" O/C PROVIDE FULL DEPTH EXPANSION JOINT @ 20'-0" O/C AND AT ALL SIDEWALK INTERSECTIONS, T's, L's AND CORNERS. DO NOT USE PRE-FORMED KEY COLD JOINTS, JOINTS SHALL ALSO LINE UP WITH BOTH SIDES OF T SLAB INTERSECTIONS.

# CONCRETE SIDEWALK CONTROL JOINT DETAIL

NOT TO SCALE

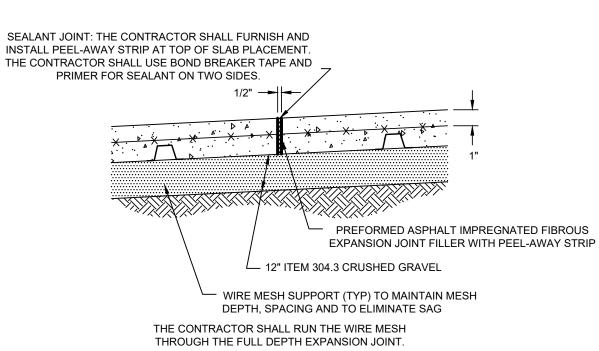

# CONCRETE SIDEWALK EXPANSION JOINT DETAIL

NOT TO SCALE

1. THE MAXIMUM ALLOWABLE SIDEWALK AND CURB RAMP CROSS SLOPES SHALL BE 2.0% (1.5% DESIGN)

2. THE MAXIMUM ALLOWABLE SLOPE OF ACCESSIBLE ROUTE EXCLUDING CURB RAMPS SHALL BE 5%.

4. A MINIMUM OF 3 FEET CLEAR SHALL BE MAINTAINED AT ANY PERMANENT OBSTACLE IN ACCESSIBLE

8. WHERE ACCESSIBLE ROUTES ARE LESS THAN 5 FT IN WIDTH (EXCLUDING CURB) A 5 FT x 5 FT PASSING

9. ELIMINATE ALL CURBING AT RAMP (OTHER THAN VERTICAL CURBING, WHICH SHALL BE SET FLUSH)

HANDICAP ACCESSIBLE

**CURB RAMP DETAIL** 

3. THE MAXIMUM ALLOWABLE SLOPE OF ACCESSIBLE ROUTE CURB RAMPS SHALL BE 7.5%.


ROUTE (I.E., HYDRANTS, UTILITY POLES, TREE WELLS, SIGNS, ETC.)

AREA SHALL BE PROVIDED AT INTERVALS NOT TO EXCEED 200 FEET.

5. CURB TREATMENT VARIES, SEE PLANS FOR CURB TYPE.

6. BASE OF RAMP SHALL BE GRADED TO PREVENT PONDING.

7. SEE TYPICAL SIDEWALK SECTION FOR RAMP CONSTRUCTION.

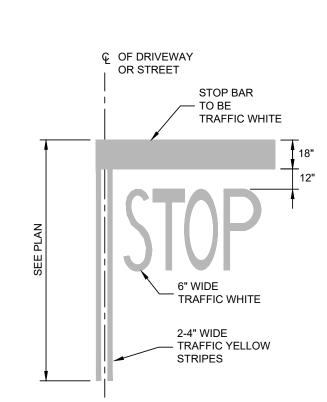

9 FT

TYP. PARKING STALL DETAIL

4" WIDE PAINTED


WHITE LINES

TIP DOWN -

R7-8P'


CURB & RAMP

# STOP BAR DETAIL NOT TO SCALE

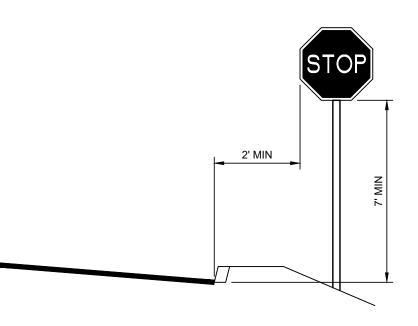

STOP SIGN LOCATION DETAIL

NOT TO SCALE

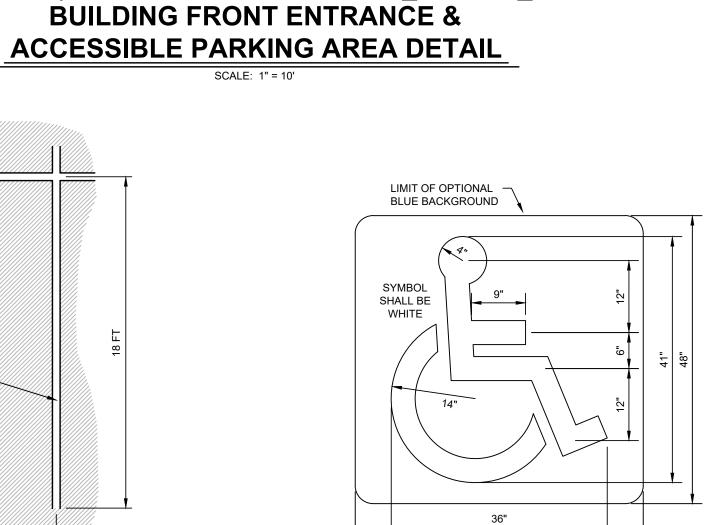


ACCESSIBLE PARKING AREAS SHALL NOT

**EXCEED 2% SLOPE IN ANY DIRECTION AND** 

COMPLY WITH ADA REGULATIONS.

# ACCESSIBLE PARKING SPACE PAVEMENT MARKING

NOT TO SCALE

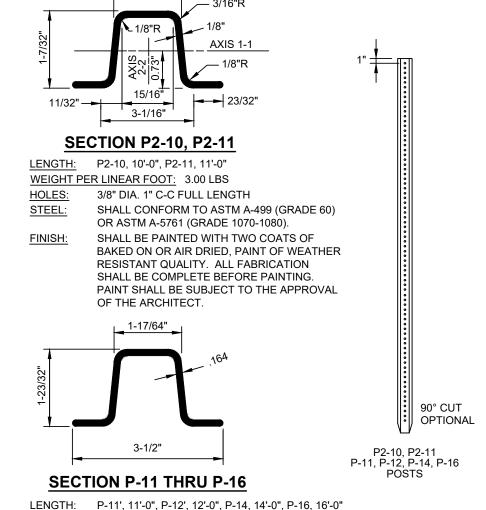

<u>LENGTH:</u> P-11', 11'-0", P-12', 12'-0", P-14, 14'-0", P-16, 16'-0"

<u>WEIGHT PER LINEAR FOOT:</u> 3.00 LBS


<u>STEEL:</u> SAME AS FOR P2-10, P2-11


<u>FINISH:</u> SAME AS FOR P2-10, P2-11

DIMENSIONS SHOWN ARE NOMINAL.


ALTERNATE SECTIONS MUST BE APPROVED PRIOR TO USE.

# TRAFFIC SIGN SUPPORT DETAIL NOT TO SCALE

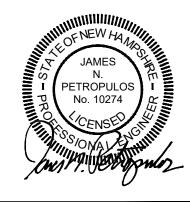

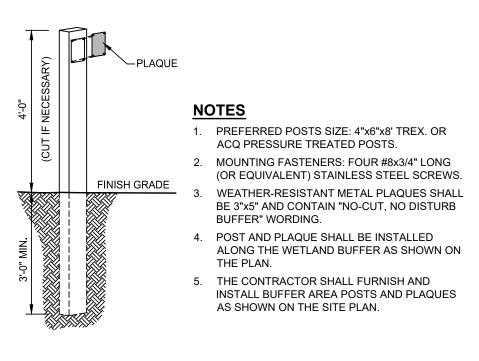

# BUFFER AREA POST & PLAQUE DETAIL

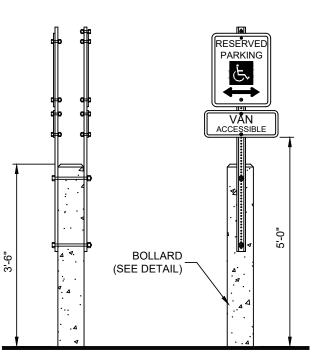

VAN ACCESSIBLE PARKING SIGN DETAIL

NOT TO SCALE



PREPARED FOR/RECORD OWNER:



SCALE AS SHOWN

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Nashua, NH 03062 Burlington, MA 01803
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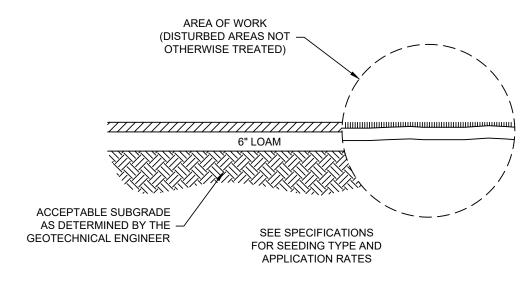
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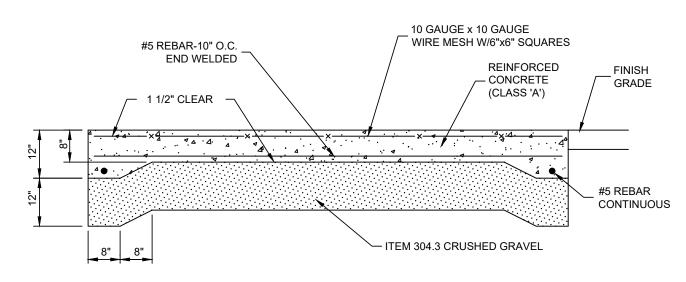
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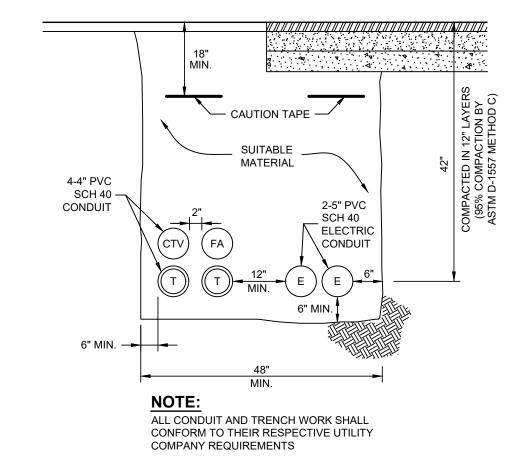
5934—SITE 9 OF




**LOAM AND SEED DETAIL** 



**DUMPSTER PAD DETAIL** 



TYPICAL UTILITY TRENCH NOT TO SCALE

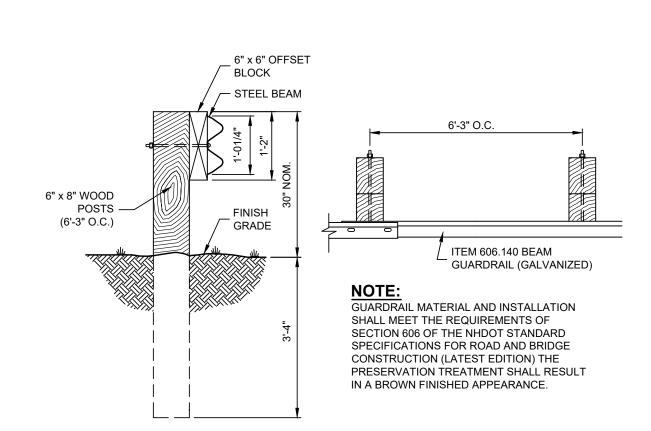

WOOD POST/BEAM TYPE **GUARDRAIL DETAIL** 

NOT TO SCALE

THE CONTRACTOR SHALL DESIGN/BUILD THE RETAINING WALLS TO THE APPROXIMATE

BACKFILL REQUIREMENTS, SHALL BE PREPARED BY A STRUCTURAL ENGINEER


FINAL SHOP DRAWINGS OF THE RETAINING WALLS, INCLUDING GUARDRAIL, FENCING AND

RETAINING WALL NOTES


LIMITS AS SHOWN ON THE PLANS.

DIMENSIONS AS SHOWN ARE APPROXIMATE.

REGISTERED IN THE STATE OF NEW HAMPSHIRE.

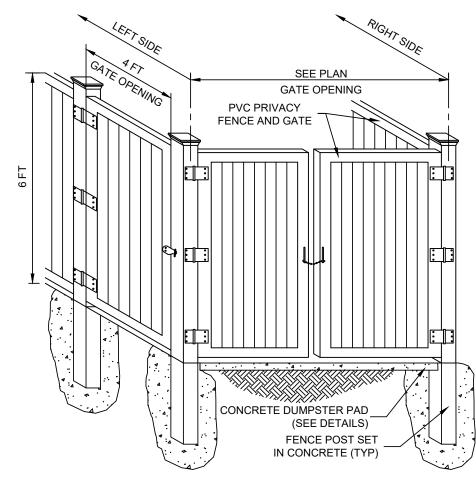


**SCREEN FENCE AND GATE** FOR DUMPSTER PAD DETAIL NOT TO SCALE

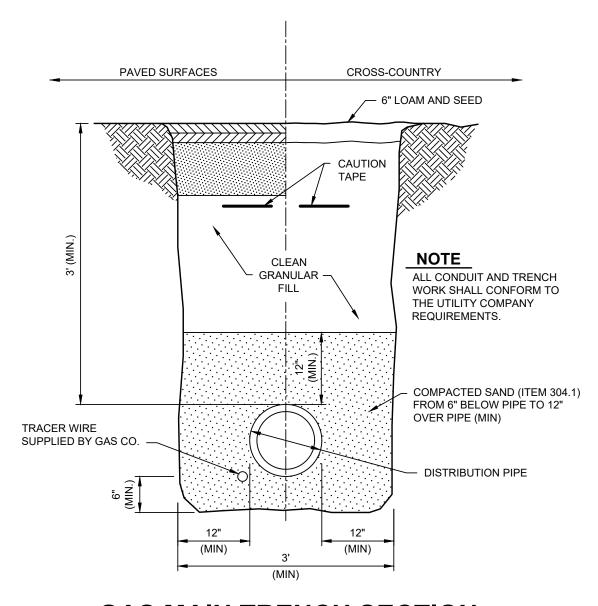


GAS MAIN TRENCH SECTION

NOT TO SCALE

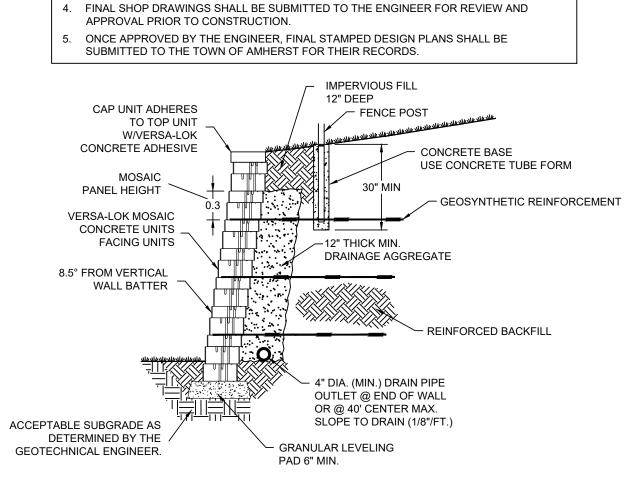

**TYPICAL SECTION -RETAINING WALL** NOT TO SCALE

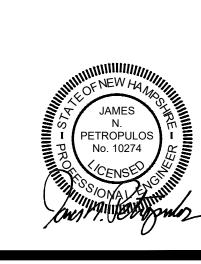



DETAIL SHEET - GENERAL SITE (MAP 2, LOT 109)

PROPOSED DENTAL OFFICE

108 PONEMAH ROAD AMHERST, NEW HAMPSHIRE

PREPARED FOR/RECORD OWNER:

AZ REALTY, LLC 12 GILBOA LANE NASHUA, NEW HAMPSHIRE 03062

SCALE AS SHOWN

I APRIL 2024




Hayner/Swanson, Inc.

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FIELD BOOK: 1276

5934-SITE | 10 OF 16 DRAWING LOC: J: \5000\5934\DWG\5934 SITE File Number



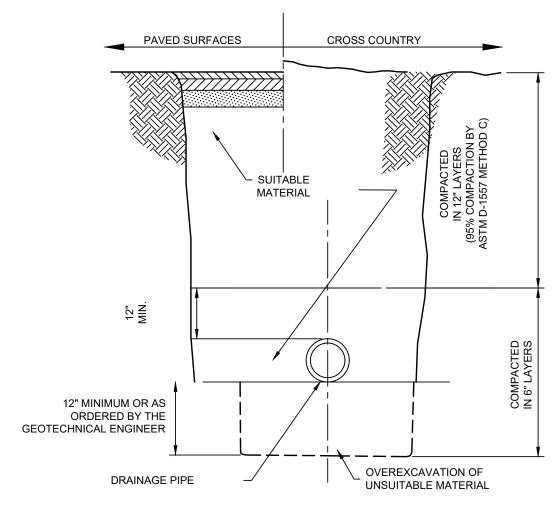

24" SQUARE FRAME AND GRATE (SEE DETAIL)

. 4 4 4 4 4

**CATCH BASIN DETAIL** 

NOT TO SCALE

6" MIN GRAVEL OR

3/4" CRUSHED STONE

ACCEPTABLE SUBGRADE

FRAME TO BE

SET IN MORTAR

PIPE TO MANHOLE (CATCH

FLEXIBLE SLEEVE AS

POLLUTION CONTROL SYSTEMS, INC., OR A-LOCK GASKET AS MANUFACTURED BY A-LOK PRODUCTS CORPORATION. ALL OTHER JOINTS SHALL BE FILLED WITH

NON-SHRINK GROUT.

BASIN) JOINTS, FOR PIPES

**EQUAL TO OR LARGER THAN** 24" DIAMETER, SHALL BE PROVIDED WITH A KOR'N'SEAL

MANUFACTURED BY NATIONAL

- CLASS "A" CONCRETE

ADJUST TO GRADE WITH

MANHOLE JOINTS SHALL BE TONGUE & GROOVE AND

SEALED WITH KENT SEAL,


OR APPROVED EQUAL.

PIPE DIAMETER VARIES

5" IF REINFORCED

8" IF UN-REINFORCED


BRICK AND MORTAR 8" MIN. - 12" MAX.

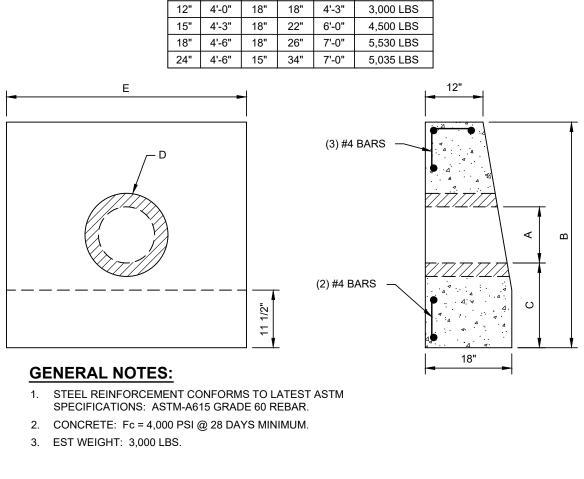


PER

SECTION


PRECAST HEADWALL DETAIL NOT TO SCALE

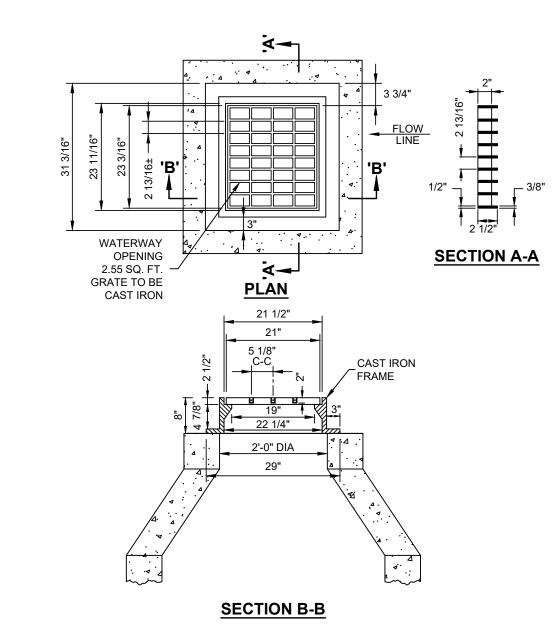



**CATCH BASIN - TYPE B** FRAME AND COVER DETAIL NOT TO SCALE

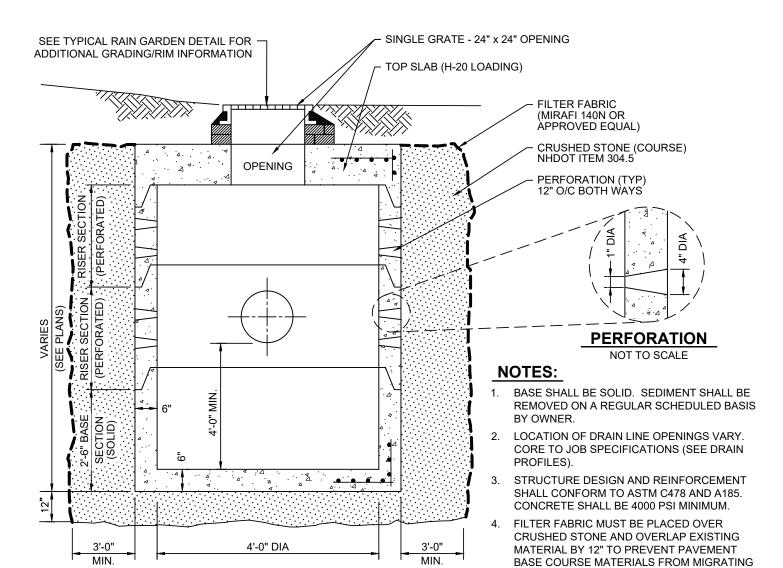

**LEACHING CATCH BASIN** 

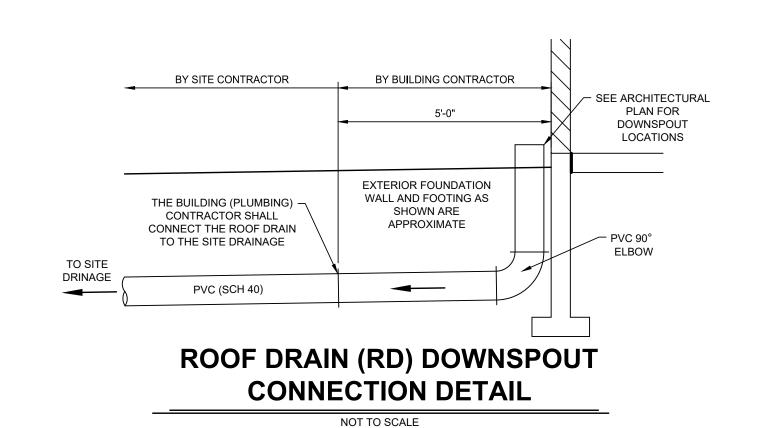


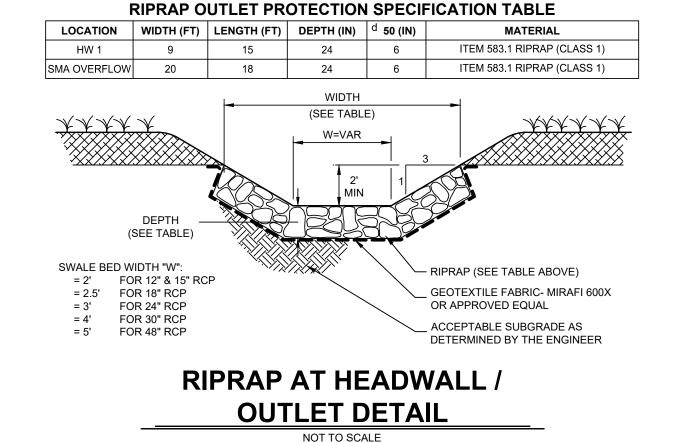

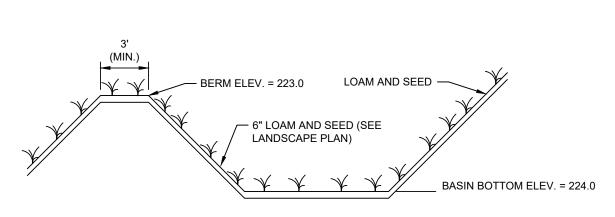

- 1. DO NOT DISCHARGE SEDIMENT-LADEN WATERS FROM CONSTRUCTION ACTIVITIES (RUNOFF, WATER FROM EXCAVATIONS) TO THE INFILTRATION BASIN.
- 2. DO NOT TRAFFIC EXPOSED SOIL SURFACE WITH CONSTRUCTION EQUIPMENT. IF FEASIBLE, PERFORM EXCAVATIONS WITH EQUIPMENT POSITIONED OUTSIDE THE LIMITS OF THE INFILTRATION BASIN.
- 3. AFTER THE BASIN IS EXCAVATED TO THE FINAL DESIGN ELEVATION, THE FLOOR SHOULD BE DEEPLY TILLED WITH A ROTARY TILLER OR DISC HARROW TO RESTORE INFILTRATION RATES, FOLLOWED BY A PASS WITH A
- 4. VEGETATION SHOULD BE ESTABLISHED IMMEDIATELY.
- 5. DO NOT PLACE INFILTRATION SYSTEMS INTO SERVICE UNTIL THE CONTRIBUTING AREAS HAVE BEEN FULLY

TYPICAL SECTION **INFILTRATION BASIN** 

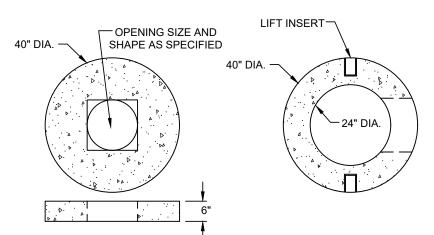


### **AVAILABLE TOP SLABS**

DIM 'A' EST. WEIGHT

24" 1,880 LBS

30" 2,290 LBS

36" 2,700 LBS 42" 3,110 LBS 48" 3,520 LBS 54" 3,930 LBS 60" 4,343 LBS

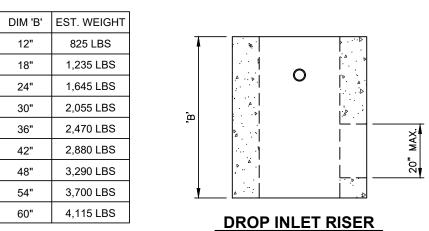




lanana.

**CAST IRON** 

FRAME & **GRATE** 

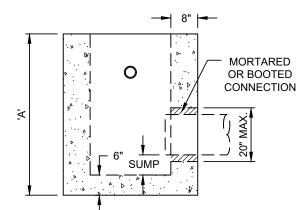

#### DROP INLET BASE

#### **GENERAL NOTES**

- 1. CONCRETE: Fc = 4,000 PSI AT 28 DAYS MINIMUM.
- 2. DESIGN LOADING: AASHTO-HS20-44.

### 3. SUMP SHALL BE 2 FT.

YARD DRAIN DETAIL NOT TO SCALE



PROPOSED DENTAL OFFICE 108 PONEMAH ROAD AMHERST, NEW HAMPSHIRE

PREPARED FOR/RECORD OWNER:

AZ REALTY, LLC 12 GILBOA LANE NASHUA, NEW HAMPSHIRE 03062

SCALE AS SHOWN


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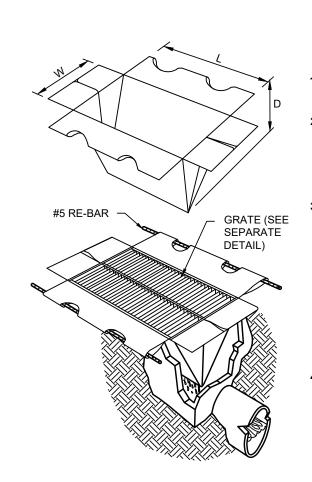


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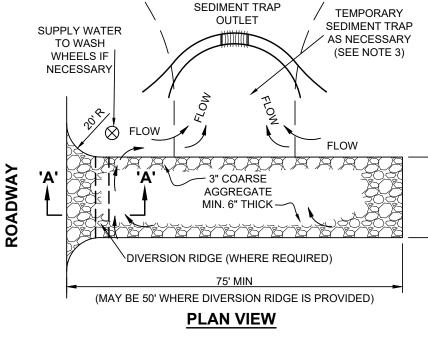




#### **SILTSAK® NOTES:**

- 1.0 THE SILTSAK® SHALL BE MANUFACTURED FROM WOVEN POLYPROPYLENE AND SEWN BY A DOUBLE NEEDLE MACHINE, USING A HIGH STRENGTH NYLON THREAD. 2.0 THE SILTSAK® SEAMS SHALL HAVE A CERTIFIED AVERAGE WIDE WIDTH STRENGTH PER ASTM D-4884 STANDARDS AS FOLLOWS
- SILTSAK® STYLE TEST METHOD TEST METHOD REGULAR FLOW ASTM D-4884 165.O LBS/IN ASTM D-4884 114.6 LBS/IN HI-FLOW 3.0 THE SILTSAK® WILL BE MANUFACTURED TO FIT THE OPENING OF THE CATCH BASIN OR DROP INLET. THE SILTSAK® WILL HAVE THE FOLLOWING FEATURES: TWO DUMP STRAPS ATTACHED AT THE BOTTOM TO FACILITATE THE EMPTYING OF THE SILTSAK®; THE SILTSAK® SHALL HAVE LIFTING LOOPS AS AN INTEGRAL PART OF THE SYSTEM TO BE USED TO LIFT THE SILTSAK® FROM THE BASIN; THE SILTSAK® SHALL HAVE A RESTRAINT CORD APPROXIMATELY HALFWAY UP THE SACK TO KEEP THE SIDES AWAY FROM THE CATCH BASIN WALLS, THIS YELLOW CORD IS ALSO A VISIBLE MEANS OF INDICATING WHEN THE SACK SHOULD BE EMPTIED, CLEANED, AND PLACED BACK INTO THE BASIN.
- 4.0 THE GEOTEXTILE FABRIC SHALL BE WOVEN POLYPROPYLENE FABRIC WITH THE PROPERTIES OF SILTSAK® REGULAR FLOW OR SILTSAK® HI-FLOW PER MANUFACTURERS SPECIFICATIONS.
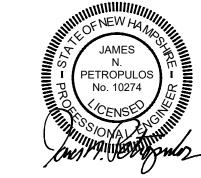
# SILTSAK® DETAIL




# **DIVERSION RIDGE** REQUIRED WHERE \_ 3"-6" OR GREATER OR GREATER **GRADE EXCEEDS 2%**

### **SECTION 'A'-'A' VIEW**

- THE EXIT SHALL BE MAINTAINED IN A CONDITION THAT WILL PREVENT TRACKING OR FLOWING OF SEDIMENT ONTO PUBLIC RIGHT-OF-WAYS. THIS MAY REQUIRE TOP DRESSING, REPAIR AND/OR CLEAN OUT OF ANY MEASURES USED TO TRAP SEDIMENT
- WHEN NECESSARY, WHEELS SHALL BE CLEANED PRIOR TO EXITING THE SITE ONTO A PUBLIC RIGHT-OF-WAY WHEN WASHING IS REQUIRED, IT SHALL BE DONE ON AN AREA STABILIZED WITH CRUSHED STONE THAT DRAINS INTO AN APPROVED SEDIMENT TRAP OR SEDIMENT BASIN.
- 4. CONSTRUCTION SPECIFICATIONS AND MAINTENANCE REQUIREMENTS SHOWN IN NHDES STORMWATER MANUAL VOLUME 3.

# **TEMPORARY GRAVEL CONSTRUCTION EXIT**

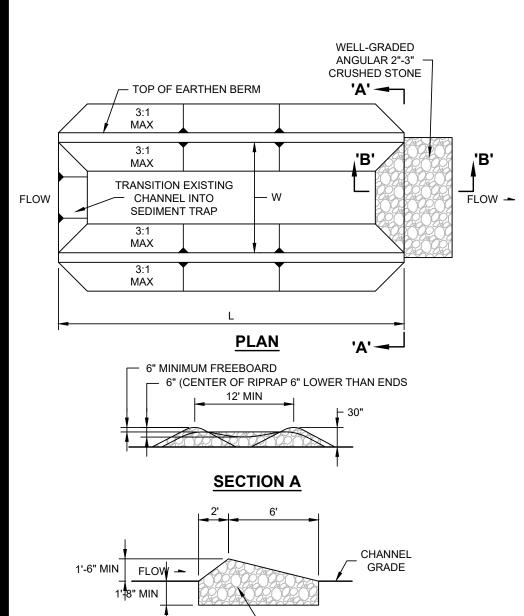

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### SEDIMENT TRAP INSTALLATION NOTES

- -LOCATION, LENGTH AND WIDTH OF SEDIMENT TRAP. SEDIMENT TRAPS SHALL BE SIZED TO PROVIDE A VOLUME OF
- 3.600 PER ACRE OF CONTRIBUTING DRAINAGE AREA. SEDIMENT TRAPS SHALL BE INSTALLED PRIOR TO ANY
- UPGRADIENT LAND-DISTURBING ACTIVITIES. SEDIMENT TRAP BERM SHALL BE CONSTRUCTED FROM MATERIAL FROM EXCAVATION. THE BERM SHALL BE COMPACTED TO 95% OF THE MAXIMUM DENSITY IN
- ACCORDANCE WITH ASTM D698. SEDIMENT TRAP OUTLET TO BE CONSTRUCTED OF WELL-GRADED ANGULAR 2"-3" CRUSHED STONE.
- THE TOP OF THE EARTHEN BERM SHALL BE A MINIMUM OF 6" HIGHER THAN THE TOP OF THE OUTLET STRUCTURE.
- THE ENDS OF THE OUTLET STRUCTURE SHALL BE A MINIMUM OF 6" HIGHER THAN THE CENTER OF THE OUTLET

### **SEDIMENT TRAP MAINTENANCE NOTES:**

- 1. INSPECT BMPs EACH WORKDAY, AND MAINTAIN THEM IN EFFECTIVE OPERATING CONDITION, MAINTENANCE OF BMPs SHOULD BE PROACTIVE, NOT REACTIVE. INSPECT BMPs AS SOON AS POSSIBLE (AND ALWAYS WITHIN 24 HOURS) FOLLOWING A STORM THAT CAUSES SURFACE EROSION.
- 2. FREQUENT OBSERVATIONS AND MAINTENANCE ARE NECESSARY TO MAINTAIN BMPs IN EFFECTIVE OPERATING CONDITION. INSPECTIONS AND CORRECTIVE MEASURES SHOULD BE DOCUMENTED THOROUGHLY WHERE BMPs HAVE FAILED. REPAIR OR REPLACEMENT

AND PERFORM NECESSARY MAINTENANCE.

- SHOULD BE INITIATED UPON DISCOVERY OF THE FAILURE. 4. REMOVE SEDIMENT ACCUMULATED IN TRAP AS NEEDED TO MAINTAIN THE FUNCTIONALITY OF THE BMP. TYPICALLY WHEN THE SEDIMENT DEPTH REACHES 1/2 THE HEIGHT OF THE OUTLET
- 5. SEDIMENT TRAPS SHALL REMAIN IN PLACE UNTIL THE CONTRIBUTING DISTURBED AREA IS STABILIZED 6. WHEN SEDIMENT TRAPS ARE REMOVED. THE DISTURBED AREA SHALL BE COVERED WITH TOPSOIL, SEEDED AND


MULCHED OR OTHERWISE STABILIZED.

# SEDIMENT TRAP DETAIL

WELL-GRADED ANGULAR

2"-3" CRUSHED STONE

NOT TO SCALE

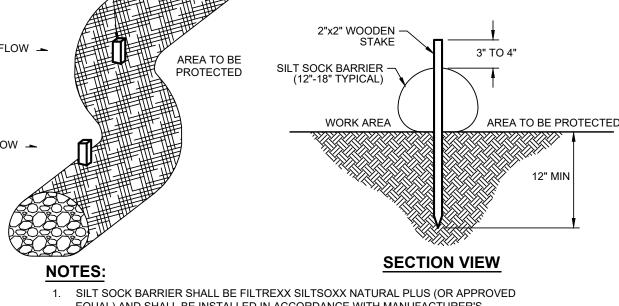


- EQUAL) AND SHALL BE INSTALLED IN ACCORDANCE WITH MANUFACTURER'S RECOMMENDATIONS
- 2. SILT SOCK BARRIER SHALL BE INSPECTED IMMEDIATELY AFTER EACH RAINFALL AND AT LEAST DAILY DURING PROLONGED RAINFALL. ANY REPAIRS THAT ARE REQUIRED
- SHALL BE MADE IMMEDIATELY 3. IF THE SILT SOCK SHOULD DECOMPOSE OR BECOME INEFFECTIVE, THE BARRIER
- SHALL BE REPLACED PROMPTLY. 4. SEDIMENT DEPOSITS SHOULD BE INSPECTED AFTER EVERY STORM EVENT. THE DEPOSITS SHOULD BE REMOVED WHEN THEY REACH APPROXIMATELY ONE-THIRD THE
- 5. SEDIMENT DEPOSITS THAT ARE REMOVED OR LEFT IN PLACE AFTER THE BARRIER HAS BEEN REMOVED SHALL BE GRADED TO CONFORM WITH THE EXISTING TOPOGRAPHY
- 6. COMPOST TO BE REMOVED OR DISPOSED ON-SITE AS DETERMINED BY THE ENGINEER.

# SILT SOCK DETAIL


KEY STONE INTO CHANNEL BANKS AND EXTEND IT BEYOND THE ABUTMENTS A MINIMUM OF 18" TO

#### **VIEW LOOKING UPSTREAM**

PREVENT FLOW AROUND THE DAM.

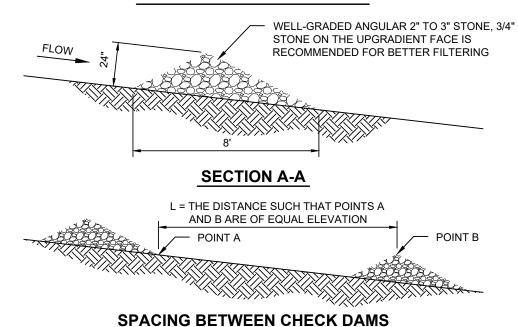

# **TEMPORARY STONE CHECK** DAM TYPICAL SECTION

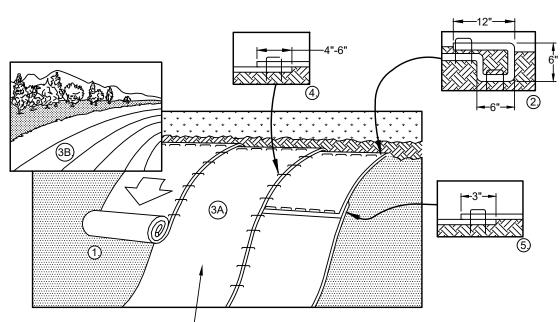

STABILIZATION MATTING BY NORTH AMERICAN GREEN BIONET S150BN, OR APPROVED EQUAL

- 1. PREPARE SOIL BEFORE INSTALLING BLANKETS, INCLUDING ANY NECESSARY APPLICATION OF LIME, FERTILIZER, AND SEED.
- 2. BEGIN AT THE TOP OF THE SLOPE BY ANCHORING THE BLANKET IN A 6" DEEP X 6" WIDE TRENCH WITH APPROXIMATELY 12" OF BLANKET EXTENDED BEYOND THE UP-SLOPE PORTION OF THE TRENCH. ANCHOR THE BLANKET WITH A ROW OF STAPLES/STAKES APPROXIMATELY 12" APART IN THE BOTTOM OF THE TRENCH. BACKFILL AND COMPACT THE TRENCH AFTER STAPLING. APPLY SEED TO COMPACTED SOIL AND FOLD REMAINING 12" PORTION OF BLANKET BACK OVER SEED AND COMPACTED SOIL. SECURE BLANKET OVER COMPACTED SOIL WITH A ROW OF STAPLES/STAKES SPACED APPROXIMATELY 12" APART ACROSS THE WIDTH OF THE BLANKET.
- 3. ROLL THE BLANKETS (A.) DOWN OR (B.) HORIZONTALLY ACROSS THE SLOPE. BLANKETS WILL UNROLL WITH APPROPRIATE SIDE AGAINST THE SOIL SURFACE. ALL BLANKETS MUST BE SECURELY FASTENED TO SOIL SURFACE BY PLACING STAPLES/STAKES IN APPROPRIATE LOCATIONS AS PER MANUFACTURES
- 4. 4. THE EDGES OF PARALLEL BLANKETS MUST BE STAPLED WITH MINIMUM 6" OVERLAP. TO ENSURE PROPER SEAM ALIGNMENT, PLACE THE EDGE OF THE OVERLAPPING BLANKET (BLANKET BEING INSTALLED ON TOP) EVEN WITH THE SEAM STITCH ON THE PREVIOUSLY INSTALLED BLANKET.
- 5. CONSECUTIVE BLANKETS SPLICED DOWN THE SLOPE MUST BE PLACED END OVER END (SHINGLE STYLE) WITH AN APPROXIMATE 3" OVERLAP. STAPLE THROUGH OVERLAPPED AREA, APPROXIMATELY 12" APART ACROSS ENTIRE BLANKET WIDTH.
- 6. PLACE STAPLES/STAKES PER MANUFACTURE RECOMMENDATION FOR THE APPROPRIATE SLOPE BEING

NOTE: IN LOOSE SOIL CONDITIONS, THE USE OF STAPLE OR STAKE LENGTHS GREATER THAN 6"

### STABILIZATION MATTING DETAIL

MAY BE NECESSARY TO PROPERLY SECURE THE BLANKETS.

NOT TO SCALE

### **GENERAL NOTES**

ANNUAL RYE GRASS

- ALL SOIL EROSION AND SEDIMENT CONTROL MEASURES SHALL BE IN ACCORDANCE WITH STANDARDS AND SPECIFICATIONS THEREOF IN NEW HAMPSHIRE DEPARTMENT OF ENVIRONMENTAL SERVICES STORMWATER MANUALS, VOLUME 1-3, LATEST EDITION
- THE WORK AREA SHALL BE GRADED, SHAPED, AND OTHERWISE DRAINED IN SUCH A MANNER AS TO MINIMIZE SOIL EROSION, SILTATION OF DRAINAGE CHANNELS, DAMAGE TO EXISTING VEGETATION, AND DAMAGE TO PROPERTY OUTSIDE THE LIMITS OF THE WORK AREA. SILT FENCES, STRAW BALES AND/OR DETENTION BASINS WILL BE NECESSARY TO ACCOMPLISH THIS END
- STRIPPED TOPSOIL SHALL BE STOCKPILED, WITHOUT COMPACTION, AND STABILIZED AGAINST EROSION IN ACCORDANCE WITH "TEMPORARY STABILIZATION OF DISTURBED AREAS", AS OUTLINED IN NOTE No. 4.
- TEMPORARY STABILIZATION OF DISTURBED AREAS:
- SEED BED PREPARATION: 10-10-10 FERTILIZATION TO BE SPREAD AT THE RATE OF 7 LBS PER 1,000 SF AND AGRICULTURAL LIMESTONE AT A RATE OF 90 LBS PER 1,000 SF AND INCORPORATED INTO THE SOIL. THE SOIL, FERTILIZER AND LIMESTONE SHALL BE TILLED TO PREPARE FOR SEEDING.

A. SEED MIXTURE: USE ANY OF THE FOLLOWING: RATE PER 1.000 SF DEPTH SEEDING DATES SPECIES 08/15 TO 09/15 WINTER RYE 2.5 LBS 04/15 TO 10/15 OATS 2.5 LBS

0.25"

TO VEGETATE

08/15 TO 09/15

BE ANCHORED TO BE USED ALONE

B. MULCHING: MULCH SHOULD BE USED ON HIGHLY ERODABLE AREAS, AND WHERE

1.0 LBS

CONSERVATION OF MOISTURE WILL FACILITATE PLANT ESTABLISHMENT AS FOLLOWS: RATE PER 1,000 SF USE & COMMENTS 70 TO 90 LBS MAY BE USED WITH PLANTINGS, MUST

WOOD CHIPS OR 460 TO 920 LBS USED WITH TREE AND SHRUB BARK MULCH PLANTINGS FIBROUS MATTING AS RECOMMENDED MUST BE BIODEGRADABLE. USE IN SLOPE AREAS AND AREAS DIFFICULT BY MANUFACTURER

CRUSHED STONE SPREAD TO GREATER USE IN SPECIFIC AREAS AS SHOWN ON 1/4" TO 1 1/2" DIA THAN 1/2" THICKNESS PLAN OR AS NEEDED.

PERMANENT STABILIZATION OF DISTURBED AREAS:

- A. ALL ROADWAYS SHALL BE STABILIZED WITHIN 72 HOURS OF ACHIEVING FINISHED GRADE B. ALL CUT AND FILL SLOPES SHALL BE SEEDED/LOAMED WITHIN 72 HOURS OF ACHIEVING FINISHED
- THE SMALLEST PRACTICAL AREA SHALL BE DISTURBED DURING CONSTRUCTION.
- AN AREA SHALL BE CONSIDERED STABILIZED IF ONE OF THE FOLLOWING HAS OCCURRED: A. BASE COURSE GRAVELS HAVE BEEN INSTALLED IN AREAS TO BE PAVED.
- B. A MINIMUM OF 85% VEGETATED GROWTH HAS BEEN ESTABLISHED.
- A MINIMUM OF 3 INCHES OF NON-EROSIVE MATERIAL SUCH AS STONE OR RIPRAP HAS BEEN
- D. OR, EROSION CONTROL BLANKETS HAVE BEEN PROPERLY INSTALLED
- ALL AREAS SHALL BE STABILIZED WITHIN 45 DAYS OF INITIAL DISTURBANCE. SITE LOCATION:
- 42° 49' 08" N LATITUDE, 71° 36' 20" W LONGITUDE (PER GOOGLE EARTH)
- 10. TOTAL AREA OF DISTURBED SOILS: 67,950± SF.
- REFERENCE IS MADE TO THE LATEST EDITION OF THE FEDERAL REGISTER (63 FR 7857), ENVIRONMENTAL PROTECTION AGENCY NPDES GENERAL PERMITS FOR STORMWATER DISCHARGES FROM CONSTRUCTION
- ACTIVITIES. FOR ADDITIONAL INFORMATION CONTACT (202) 564-9545 OR www.epa.gov/npdes/stormwater THE ENTIRE CONTENTS OF THE STORMWATER POLLUTION PREVENTION PLAN (SWPPP) SHALL BE RETAINED ON-SITE FOR THE DURATION OF THE CONTRACT AND BE MADE AVAILABLE TO LOCAL, STATE AND FEDERAL CODE ENFORCEMENT PERSONNEL
- THIS PROJECT SHALL BE MANAGED TO MEET THE REQUIREMENTS AND INTENT OF RSA 430:63 AND AGR 3800 RELATIVE TO INVASIVE SPECIES; AND FUGITIVE DUST IS CONTROLLED IN ACCORDANCE WITH ENV-A
- TURF REINFORCEMENT MATS, IF UTILIZED, SHALL BE COVERED WITH SOIL TO PREVENT EXPOSURE OF
- THERE SHALL BE NO PLASTIC, OR MULTI-FILAMENT OR MONOFILAMENT POLYPROPYLENE NETTING OR MESH WITH AN OPENING SIZE OF GREATER THAN 1/8 INCHES MATERIAL UTILIZED (NOT APPLICABLE TO

## WINTER CONDITION NOTES

**FILE THE EPA NOTICE OF** 

INTENT (NOI) FORM AT

**LEAST 14 DAYS PRIOR TO** 

CONSTRUCTION

- ALL PROPOSED POST-DEVELOPMENT VEGETATED AREAS WHICH DO NOT EXHIBIT A MINIMUM OF 85% VEGETATIVE GROWTH BY OCTOBER 15TH, OR WHICH ARE DISTURBED AFTER OCTOBER 15TH, SHALL BE STABILIZED BY SEEDING AND INSTALLING EROSION CONTROL BLANKETS ON SLOPES GREATER THAN 3:1 AND SEEDING AND PLACING 3 TO 4 TONS OF MULCH PER ACRE. SECURED WITH ANCHORED NETTING ELSEWHERE. THE PLACEMENT OF EROSION CONTROL BLANKETS OR MULCH AND NETTING SHALL NOR OCCUR OVER ACCUMULATED SNOW OR ON FROZEN GROUND AND SHALL BE COMPLETED IN ADVANCE OF THAW OR SPRING MELT EVENTS.
- ALL DITCHES OR SWALES WHICH DO NOT EXHIBIT A MINIMUM OF 85% VEGETATIVE GROWTH BY OCTOBER 15<sup>TH</sup>, OR WHICH ARE DISTURBED AFTER OCTOBER 15<sup>TH</sup>, SHALL BE STABILIZED WITH STONE OR EROSION CONTROL BLANKETS APPROPRIATE FOR THE DESIGN FLOW CONDITIONS.
- MINIMUM OF 3-INCHES OF CRUSHED GRAVEL PER NHDOT ITEM 304.3.

AFTER OCTOBER 15TH, INCOMPLETE ROAD OR PARKING SURFACES SHALL BE PROTECTED WITH A

### SITE MAINTENANCE/INSPECTION PROGRAM

THE FOLLOWING PROVIDES AN ITEMIZATION OF SPECIFIC SITE MAINTENANCE PRACTICES THAT WILL BE EMPLOYED ON THE SITE TO MINIMIZE POLLUTANT GENERATION AND TRANSPORT FROM THE SITE. THE SITE MAINTENANCE PROGRAM INCLUDES ROUTINE INSPECTIONS, PREVENTATIVE MAINTENANCE AND "GOOD HOUSEKEEPING" PRACTICES.

#### **ROUTINE INSPECTIONS**

THE CONTRACTOR SHALL INSPECT ALL CONTROL MEASURES AT LEAST ONCE A WEEK AND WITHIN TWENTY-FOUR (24) HOURS OF THE END OF A STORM WITH RAINFALL AMOUNT GREATER THAN 0.25 INCHES. THE INSPECTIONS WILL VERIFY THAT THE STRUCTURAL BMPs DESCRIBED IN THE PLANS ARE IN GOOD CONDITION AND ARE MINIMIZING FROSION A MAINTENANCE INSPECTION REPORT WILL BE MADE WITH EACH INSPECTION COMPLETED INSPECTION FORMS SHALL BE KEPT ON-SITE FOR THE DURATION OF THE PROJECT, FOLLOWING CONSTRUCTION, THE COMPLETED FORMS SHALL BE RETAINED AT THE CONTRACTOR'S OFFICE FOR A MINIMUM

#### PREVENTATIVE MAINTENANCE

THE CONTRACTOR SHALL BE RESPONSIBLE FOR MAINTENANCE OF ALL TEMPORARY AND PERMANENT CONTROLS THROUGHOUT THE DURATION OF THIS CONTRACT. MAINTENANCE PRACTICES SHALL INCLUDE, BUT

2. CLEANING OF SEDIMENT AND DEBRIS FROM STORMWATER MANAGEMENT AREA FOREBAY TWICE PER

1. CLEANING OF CATCH BASINS AND YARD DRAINS TWICE PER YEAR OR MORE FREQUENTLY AS DICTATED

- YEAR OR MORE FREQUENTLY AS DICTATED BY MONTHLY INSPECTIONS.
- 3. IMPLEMENTATION OF OTHER MAINTENANCE OR REPAIR ACTIVITIES AS DEEMED NECESSARY BASED UPON WEEKLY INSPECTIONS.

7. TREATMENT OF NON-STORM WATER DISCHARGES SUCH AS WATER FROM WATER LINE FLUSHINGS OR

GROUNDWATER FROM DEWATERING EXCAVATIONS. SUCH FLOWS SHOULD BE DIRECTED TO A

- 4. REMOVAL OF BUILT UP SEDIMENT ALONG SILT SOCKS AND/OR STONE CHECK DAMS.
- 5. REMOVAL OF BUILT UP SEDIMENT IN BOTH TEMPORARY AND PERMANENT CONTROLS SUCH AS GRASS SWALES, SEDIMENT FOREBAYS AND RECHARGE/DETENTION BASINS.
- 6. RECONSTRUCTING THE TEMPORARY GRAVEL CONSTRUCTION EXIT IF NOT WORKING PROPERLY.
- TEMPORARY SEDIMENTATION BASIN OR STORMWATER MANAGEMENT AREA. 8. SWEEP PARKING LOTS AND DRIVES REGULARLY TO MINIMIZE SEDIMENT ACCUMULATION. FREQUENCY WILL VARY SEASONALLY ACCORDING TO SEDIMENT ACCUMULATION ON PAVE SURFACES (E.G., MORE

#### **GOOD HOUSEKEEPING PRACTICES**

FREQUENT SWEEPING DURING THE WINTER AND SPRING).

THE CONTRACTOR SHALL EMPLOY MEASURES AND PRACTICES TO REDUCE THE RISK OF SPILLS OR OTHER ACCIDENTAL EXPOSURE OF MATERIALS TO STORM AND WATER RUNOFF. THE CONTRACTOR SHALL PAY SPECIAL ATTENTION TO THE HANDLING, USE AND DISPOSAL OF MATERIALS SUCH AS PETROLEUM PRODUCTS FERTILIZERS AND PAINTS TO ENSURE THAT THE RISK ASSOCIATED WITH THE USE OF THESE PRODUCTS IS MINIMIZED. THE FOLLOWING "GOOD HOUSEKEEPING" PRACTICES SHALL BE FOLLOWED DURING CONSTRUCTION

- OF THE PROJECT: A. AN EFFORT SHALL BE MADE TO STORE ONLY ENOUGH PRODUCT REQUIRED TO DO THE JOB.
- B. ALL MATERIALS STORED ON-SITE SHALL BE STORED IN A NEAT, ORDERLY MANNER IN THEIR
- APPROPRIATE CONTAINERS AND, IF POSSIBLE, UNDER A ROOF OR OTHER ENCLOSURE. C. PRODUCTS SHALL BE KEPT IN THEIR ORIGINAL CONTAINERS WITH THEIR MANUFACTURERS' LABELS
- D. WHENEVER POSSIBLE, ALL OF A PRODUCT SHALL BE USED BEFORE DISPOSING OF THE CONTAINER.
- E. MANUFACTURERS' RECOMMENDATIONS FOR PROPER USE AND DISPOSAL SHALL BE FOLLOWED. F. THE CONTRACTOR SHALL INSPECT DAILY TO ENSURE PROPER USE AND DISPOSAL OF MATERIALS.

# SPILL PREVENTION AND CLEANUP PRACTICES

- MANUFACTURERS' RECOMMENDED METHODS FOR SPILL CLEANUP WILL BE CLEARLY POSTED AND SITE PERSONNEL WILL BE MADE AWARE OF THE PROCEDURES AND THE LOCATION OF THE INFORMATION AND
- MATERIALS AND EQUIPMENT NECESSARY FOR SPILL CLEANUP WILL BE KEPT IN THE MATERIAL STORAGE AREA ON-SITE. EQUIPMENT AND MATERIAL WILL INCLUDE BUT NOT BE LIMITED TO BROOMS, DUSTPANS, MOPS, RAGS, GLOVES, GOGGLES, KITTY LITTER, SAND, SAWDUST, AND PLASTIC AND METAL TRASH
- CONTAINERS SPECIFICALLY FOR THIS PURPOSE
- ALL SPILLS WILL BE CLEANED UP IMMEDIATELY AFTER DISCOVERY THE SPILL AREA WILL BE KEPT WELL VENTILATED AND PERSONNEL WILL WEAR APPROPRIATE
- PROTECTIVE CLOTHING TO PREVENT INJURY FROM CONTACT WITH A HAZARDOUS SUBSTANCE. SPILLS OF TOXIC OR HAZARDOUS MATERIAL WILL BE REPORTED TO THE APPROPRIATE STATE OR LOCAL GOVERNMENT AGENCY, REGARDLESS OF THE SIZE.
- THE SPILL PREVENTION PLAN WILL BE ADJUSTED TO INCLUDE MEASURES TO PREVENT THIS TYPE OF SPILL FROM REOCCURRING AND HOW TO CLEAN UP THE SPILL IF THERE IS ANOTHER ONE. A DESCRIPTION OF THE SPILL, WHAT CAUSED IT, AND THE CLEANUP MEASURES WILL ALSO BE INCLUDED.



DETAIL SHEET - EROSION CONTROL (MAP 2, LOT 109)

108 PONEMAH ROAD AMHERST, NEW HAMPSHIRE

PREPARED FOR/RECORD OWNER:

AZ REALTY, LLC 12 GILBOA LANE NASHUA, NEW HAMPSHIRE 03062

SCALE AS SHOWN

I APRIL 2024





131 Middlesex Turnpike 3 Congress Street

Burlington, MA 01803 (781) 203-1501 Nashua, NH 03062 (603) 883-2057 www.hayner-swanson.com

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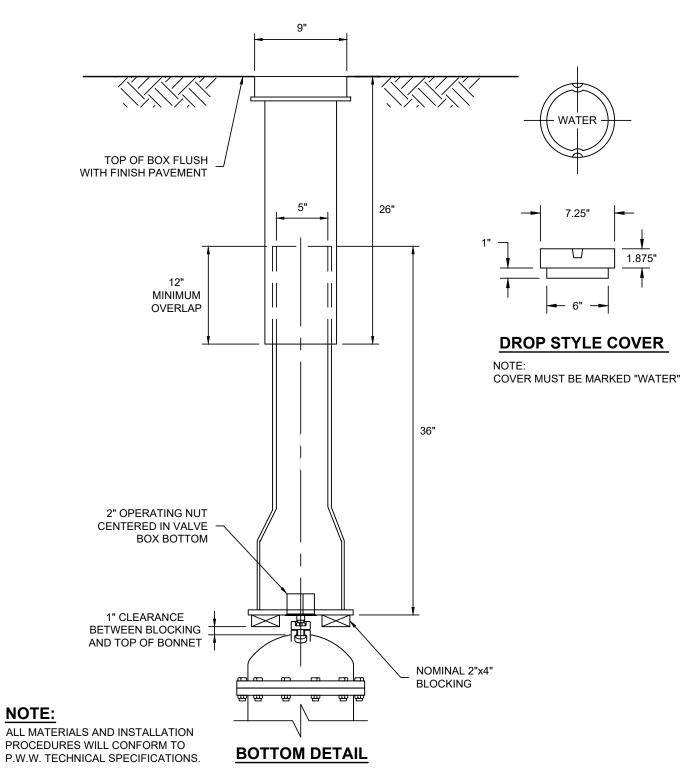
5934-SITE | 12 OF 16 DRAWING LOC: J: \5000\5934\DWG\5934 SITE File Number



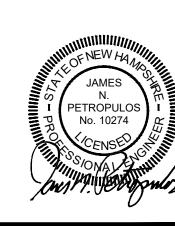


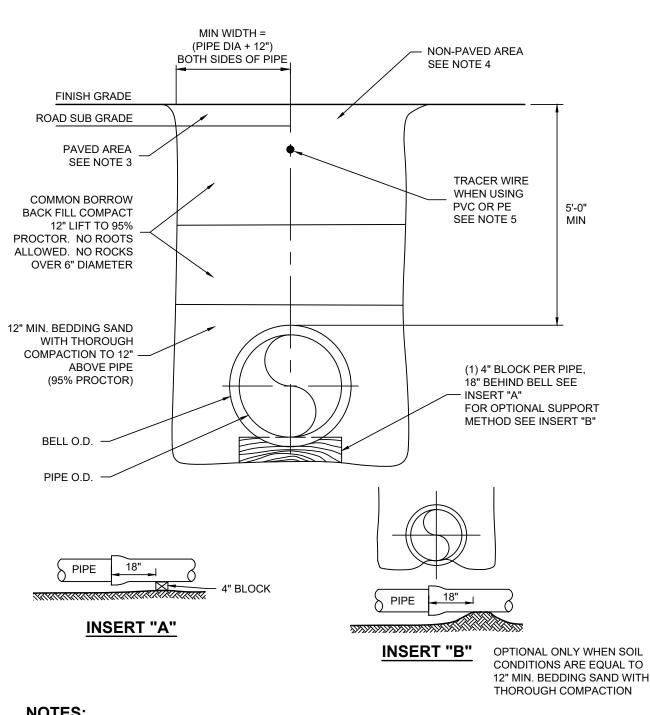
- . ALL MATERIALS AND INSTALLATION PROCEDURES WILL CONFORM TO P.W.W. TECHNICAL SPECIFICATIONS.
- 2. ALL PIPE SHOULD HAVE A MINIMUM DEPTH OF 5'-0" FROM TOP OF PIPE TO FINISH GRADE. 3. REQUIREMENTS FOR SUBBASE AND BASE MATERIAL TYPE ARE TO BE IN ACCORDANCE WITH LOCAL
- AUTHORITY HAVING LOCAL JURISDICTION IN PAVED AREAS. 4. REQUIREMENTS FOR GRAVEL, LOAM AND/OR SEED ARE TO BE IN ACCORDANCE WITH LOCAL
- AUTHORITY HAVING LOCAL JURISDICTION IN NON-PAVED AREAS. 5. USE 10-GAUGE SOLID-CORE COATED BLUE TRACER WIRE PER P.W.W. TECHNICAL SPECIFICATIONS.

# TYPICAL TRENCH DETAIL



**TYPICAL VALVE BOX DETAIL** 

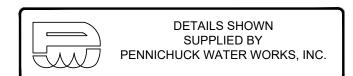

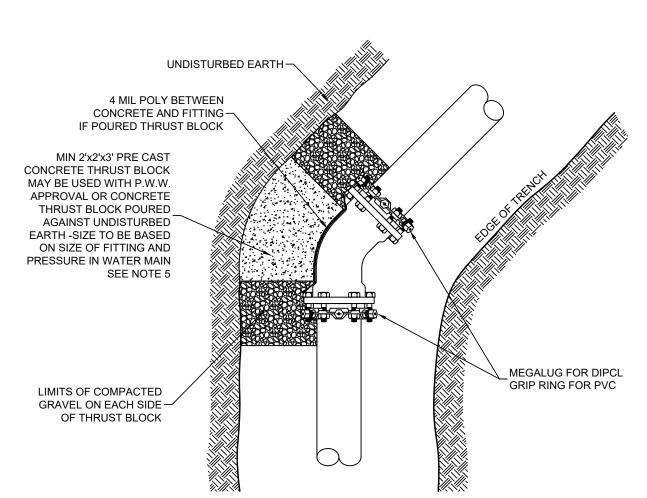


1. ALL MATERIAL AND INSTALLATION PROCEDURES WILL CONFORM TO P.W.W. TECHNICAL SPECIFICATIONS.

10" FITTING OR SMALLER = (2) 3/4"Ø S.S. RODS & ASSOC. HARDWARE.

- 2. ALL PIPE SHOULD HAVE A MINIMUM DEPTH 5'-0" FROM TOP OF PIPE TO FINISH GRADE. 3. 3/4"Ø S.S. RODS SHALL BE USED IN CONJUNCTION WITH REQUIRED S.S. NUTS. RODS ARE TO BE ATTACHED TO FITTINGS WITH EITHER STAR BOLTS OR DUC LUGS.
- 12" FITTING OR LARGER = (4) 3/4"Ø S.S. RODS & ASSOC. HARDWARE. 4. MIN 2'x2'x3' PRE CAST CONCRETE THRUST BLOCK MAY BE USED WITH P.W.W. APPROVAL OR CONCRETE THRUST BLOCK POURED AGAINST UNDISTURBED EARTH - SIZE TO BE BASED ON
- SIZE OF FITTING AND PRESSURE IN WATER MAIN. 5. VOID BETWEEN PRECAST THRUST BLOCK AND VIRGIN SOIL TO BE FILLED AND CHINKED WITH

# TYPICAL THRUST BLOCK BEHIND FITTINGS INSTALLATION

NOT TO SCALE

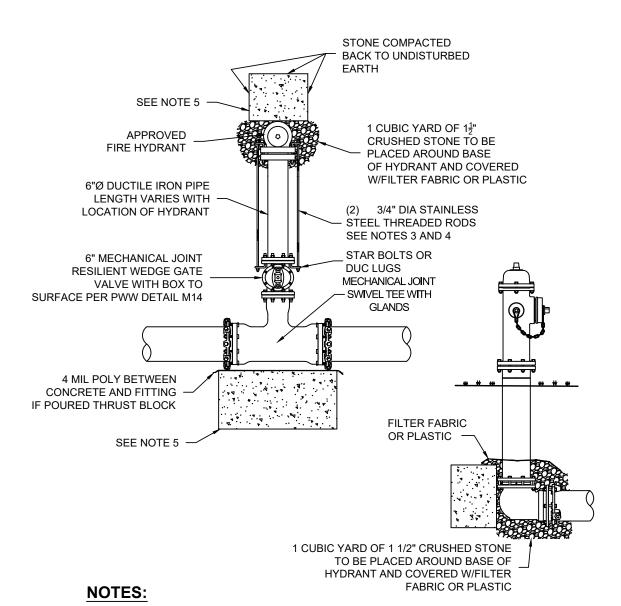


#### 1. ALL MATERIAL AND INSTALLATION PROCEDURES WILL CONFORM TO P.W.W. TECHNICAL SPECIFICATIONS.

- 2. ALL PIPE SHOULD HAVE A MINIMUM DEPTHS OF 5' FROM TOP OF PIPE TO FINISH GRADE. 3. 3/4"Ø S.S. RODS SHALL BE USED IN CONJUNCTION WITH REQUIRED S.S. NUTS. RODS ARE TO BE ATTACHED TO FITTINGS WITH EITHER STAR BOLTS OR DUC LUGS. 10" FITTING OR SMALLER = (2) 3/4"Ø S.S. RODS & ASSOC. HARDWARE. 12" FITTING OR LARGER = (4)
- 3/4"Ø S.S. RODS & ASSOC. HARDWARE. 4. WHEN DISTANCE FROM WATER MAIN TO HYDRANT IS MORE THAN 10' SUBSTITUTE
- MEGALUGS (OR GRIP RINGS) IN LIEU OF THREADED RODS. 5. MIN 2'x2'x3' PRE CAST CONCRETE THRUST BLOCK MAY BE USED WITH P.W.W. APPROVAL OR CONCRETE THRUST BLOCK POURED AGAINST UNDISTURBED EARTH - SIZE TO BE BASED ON SIZE OF FITTING AND PRESSURE IN WATER MAIN. SEE PWW DETAIL M10.

## TYPICAL HYDRANT INSTALLATION

NOT TO SCALE

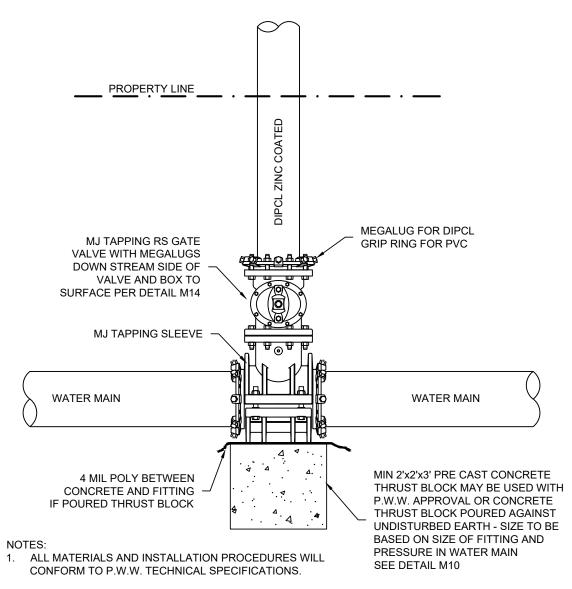

2. SEE DETAIL F01 FOR CROSS-SECTIONAL VIEW.

# TYPICAL LARGE SERVICE AND/OR **TAPPING SLEEVE DETAIL**

NOT TO SCALE

### **WATER NOTES:**

- 1. REFERENCE PENNICHUCK WATER WORKS SPECIFICATIONS FOR INSTALLATION OF ALL WATER LINES.
- 2. ALL SPRINKLER AND DOMESTIC LEADS TO BUILDING SHALL END 5'-0" OUTSIDE THE FACE OF BUILDING WALL, UNLESS NOTED, AND SHALL BE PROVIDED WITH A TEMPORARY PLUG AT END (FOR OTHERS TO REMOVE AND EXTEND AS
- 3. THRUST BLOCKS AND MEGALUG RESTRAINTS SHALL BE PROVIDED AT ALL HORIZONTAL BENDS, TEES, AND FIRE HYDRANTS. SEE DETAIL.
- 4. MINIMUM COVER ON ALL WATER LINES IS 5'-0". 5. CONTRACTOR SHALL MAINTAIN A 5'-0" HORIZONTAL (UNLESS OTHERWISE NOTED) AND 12" VERTICAL SEPARATION
- BETWEEN WATER SERVICE AND UTILITIES OTHER THAN SANITARY SEWER. 6. INSPECTIONS ON WATER SERVICE INSTALLATION DURING CONSTRUCTION IS THE RESPONSIBILITY OF THE SITE
- CONTRACTOR AND SHALL BE COORDINATED WITH PENNICHUCK WATER WORKS, AND ALL INSPECTION FEES SHALL BE
- 7. CONTRACTOR SHALL HAVE BACTERIOLOGICAL AND PRESSURE TESTING PERFORMED. CONTRACTOR SHALL GIVE PENNICHUCK WATER WORKS A COPY OF RESULTS. PENNICHUCK WATER WORKS SHALL BE ON-SITE TO WITNESS TEST.
- 8. ALL PIPE, VALVES, MISCELLANEOUS MATERIALS AND INSTALLATION SHALL CONFORM WITH PENNICHUCK WATER WORKS SPECIFICATIONS.
- 9. ALL FIRE HYDRANTS, VALVES, FITTINGS, PIPES, ETC. SHALL BE IN ACCORDANCE WITH PENNICHUCK WATER WORKS REQUIREMENTS.
- 10. METALLIC TAPE OR DETECTOR WIRE SHALL BE INSTALLED IN THE SAME TRENCH WITH ALL NONMETALLIC PIPE SUCH THAT THE PIPE MAY BE LOCATED WITH ELECTRONIC LOCATING EQUIPMENT, DETECTOR WIRE OR METALLIC TAPE SHALL BE INSTALLED APPROXIMATELY 12" TO 18" BELOW GRADE DIRECTLY ABOVE THE TOP OF THE PIPE. DETECTOR WIRE SHALL BE 14 - GAUGE SOLID COPPER, SIMPLEX BW3001, OR EQUAL. METALLIC TAPE SHALL BE 2" MINIMUM METALIZED TAPE, GRIFFOLYN COMPANY, INC. TERRATAPE OR EQUAL.
- 11. CONTRACTOR SHALL ENSURE ALL WATER VALVES ARE IN A FULLY-OPEN POSITION UPON COMPLETION OF PROJECT.
- 12. CONTRACTOR SHALL COORDINATE ALL WATER INTERRUPTIONS WITH THE PENNICHUCK WATER WORKS AND AFFECTED PROPERTY OWNERS



DETAIL SHEET - WATER (MAP 2, LOT 109)

PROPOSED DENTAL OFFICE 108 PONEMAH ROAD AMHERST, NEW HAMPSHIRE

PREPARED FOR/RECORD OWNER:

AZ REALTY, LLC 12 GILBOA LANE NASHUA, NEW HAMPSHIRE 03062

SCALE AS SHOWN


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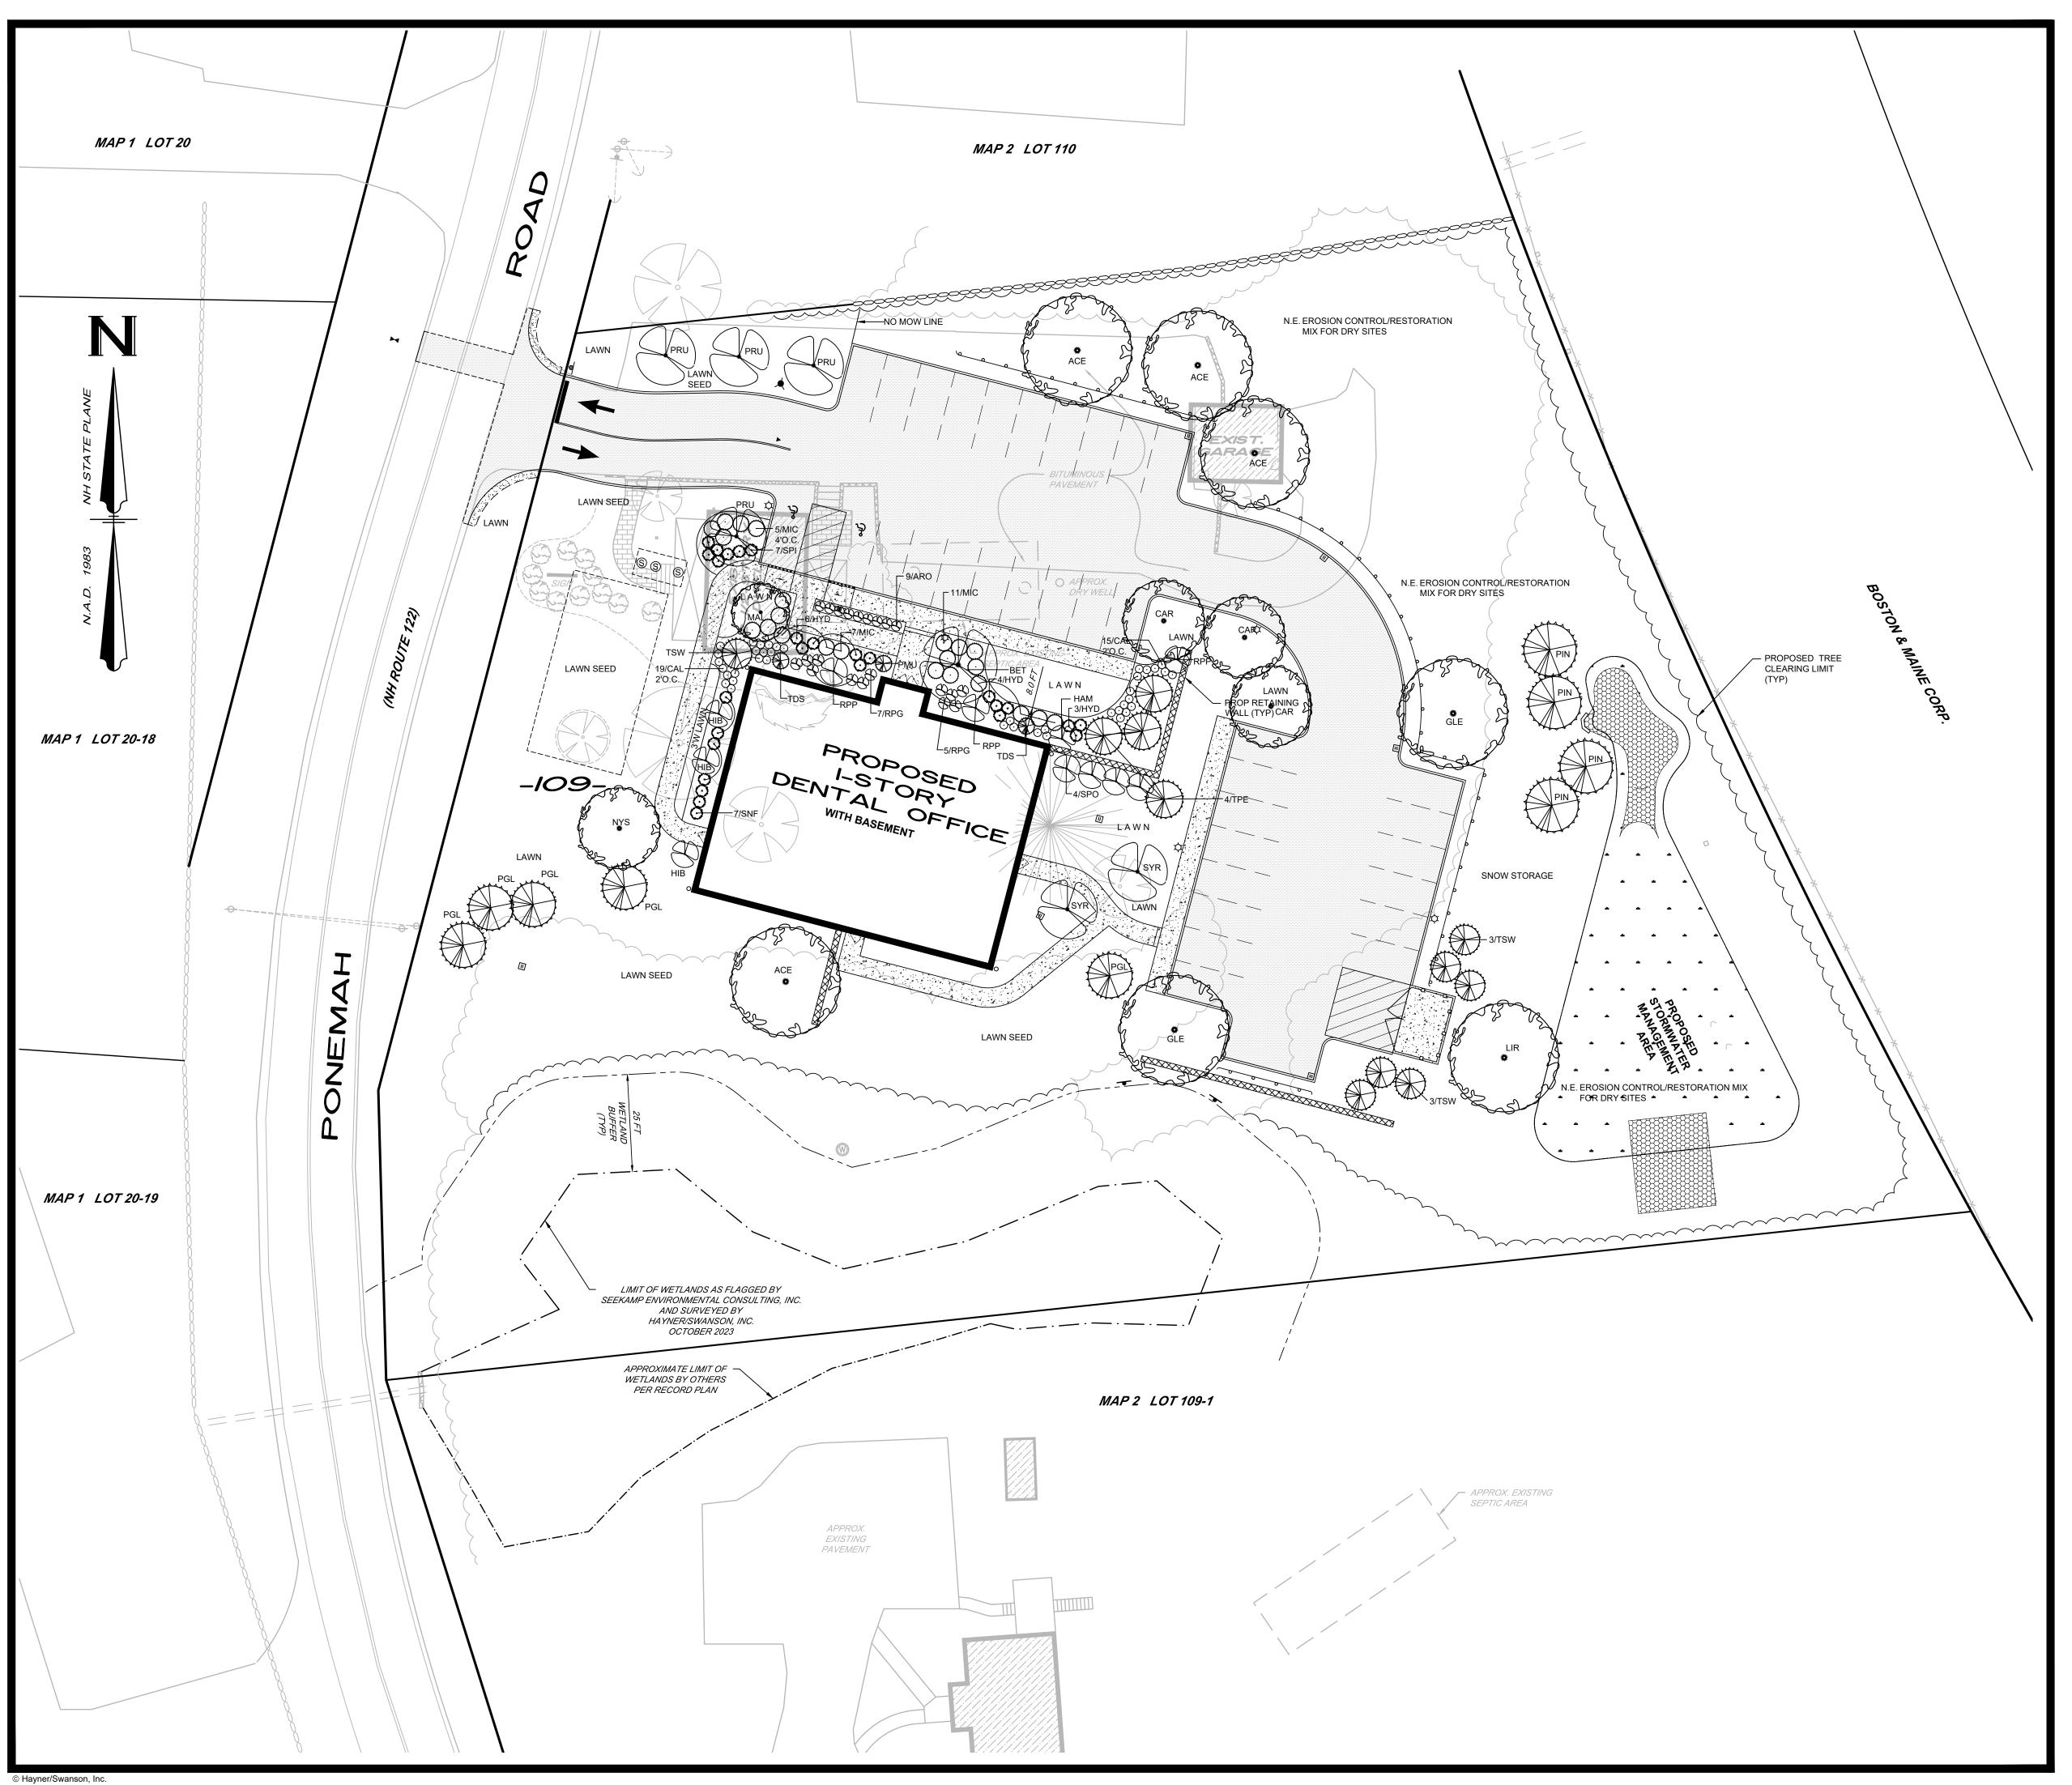


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DRAWING NAME: 5934-SITE-DET1 FIELD BOOK: 1276 5934-SITE 13 OF 16 DRAWING LOC: J: \5000\5934\DWG\5934 SITE File Number





# **LANDSCAPE MAINTENANCE NOTES:**

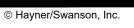- LANDSCAPING SHALL BE KEPT IN GOOD CONDITIONS AND DEAD PLANTINGS SHALL BE REPLACED.
- PERMANENT WATER SERVICE SUPPLY TO BE PROVIDED BY OTHERS.
- MAINTENANCE BOND FOR ONE YEAR TO BE PROVIDED.
- ALL CONDITIONS ON PLAN TO REMAIN IN PERPETUITY.

#### MATERIAL LIST

4/ACE ACER RUBRUM (RED MAPLE)	2.5"-3"CAL.
9/ARO ARONIA MELANOCARPA (GROUND HOG CHOKEBERRY)	#3GAL.
1/BET BETULA NIGRA HERITAGE (RIVER BIRCH)	12'-14' MULTI-STEM
40/CAL CALAMAGROSTIS A. (KARL FOERSTER FEATHER REED)	#3GAL.
3/CAR CARPINUS BETULUS (FRANS FONTAINE HORNBEAM)	2.5"-3"CAL.
2/GLE GLEDITSIA T.I. (HALKA HONEYLOCUST)	2.5"-3"CAL.
1/HAM HAMAMELIS VIRGINIANA (HARVEST MOON WITCHHAZEL)	6'-7'BB
3/HIB HIBISCUS SYRIACUS (HAWAII ROSE OF SHARON)	4'-5'BB
13/HYD HYDRANGEA (ENDLESS SUMMER (TWIST AND SHOUT )	#5GAL.
1/LIR LIRIODENDRON TULIPIFERA (EMERALD CITY TULIPTREE)	2.5"-3"CAL.
1/MAL MALUS SPECIES (LOUISA CRABAPPLE)	2"-2.5"CAL.
23/MIC MICROBIOTO DECUSSATA (RUSSIAN CYPRESS)	#5GAL.
1/NYS NYSSA SYLVATICA (FOREST FIRE TUPELO)	2.5"-3"CAL.
5/PGL PICEA GLAUCA (WHITE SPRUCE)	8'-10'BB
4/PIN PINUS STROBUS (EASTERN WHITE PINE)	5'-6'BB
1/PMU PINUS MUGO (SLOWMOUND MUGO PINE)	#10GAL.
4/PRU PRUNUS SERRULATA (KWANZAN CHERRY)	2"-2.5"CAL.
12/RPG RHODODENDRON (PURPLE GEM RHODODENDRON)	#3GAL.
3/RPP RHODODENDRON PJM (PINK PJM)	3'-4'BB
7/SNF SPIRAEA JAPONICA (NEON FLASH SPIREA)	#3GAL.
7/SPI SPIRAEA JAPONICA (DOUBLE PLAY DOOZIE SPIREA)	#3GAL
4/SPO SYRINGA HYACINTHIFLORA (POCAHONTAS LILAC)	6'-7'HVY.
2/SYR SYRINGA RETICULATA (IVORY SILK LILAC TREE)	8'-10' MULTI-STEM
2/TDS THUJA O. (DEGROOTS SPIRE ARBORVITAE)	6'-7'BB
4/TPE THUGA PLICATA (EXCELSA WESTERN ARBORVITAE)	7'-8'BB
7/TSW THUJA PLICATA (STEEPLECHASE WESTERN ARBORVITAE)	7'-8'BB
GENERAL LAWN SEED DROUGHT TOLERANT SANDY SOIL	PER PLAN
RETENTION BASIN - N.E. MOIST SITE RESTORATION MIX	PER PLAN
NOW MOWED AREAS - N.E. DRY SITE RESTORATION MIX	PER PLAN

PREMIUM BLEND PINE BARK MULCH IN ALL BEDS

PLANT MATERIAL SOURCE: MILLICAN NURSERY CHICHESTER, N.H. RESTORATION SEED MIX: NEW ENGLAND WETLAND PLANTS, AMHERST, N.H.

- THERE ARE NO SUBSTITUIONS TO THE BID LIST WITHOUT PRIOR WRITTEN CONSENT OF THE LANDSCAPE ARCHITECT. ANY INSTALLED PLANTS THAT DO NOT CONFORM TO THE BID LIST (HYBRID, SIZE) WILL BE REPLACED WITH THE CORRECT PLANTS AT THE CONTRACTOR'S EXPENSE.
- PLANT AND SEED WARRANTY FOR ONE YEAR FROM CLIENT ACCEPTANCE. INSTALLING CONTRACTOR RESPONSIBLE FOR MONTORING PROPER WATERING AND INSECT



LANDSCAPE PLAN (MAP 2, LOT 109)

PROPOSED DENTAL OFFICE 108 PONEMAH ROAD AMHERST. NEW HAMPSHIRE

PREPARED FOR/RECORD OWNER:

# AZ REALTY, LLC 12 GILBOA LANE NASHUA, NEW HAMPSHIRE 03062

20 METERS SCALE: 1"=20 Feet 1"=6.096 Meters

I APRIL 2024

PREPARED BY :

# JOSEPH HOCHREIN

PHONE (603) 648 - 6500 FAX (603) 648 - 6506 Land Planning - Landscape Architecture 85 Frost Lane - Webster, NH 03303

DRAWING NAME: 5934-SITE-LS21 5934-SITE | 14 OF 16 DRAWING LOC: J: \5000\5934\DWG\5934 SITE


#### **General Specifications**


- 1. The contractor shall at their expense furnish all the materials, supplies, machinery, equipment, tool, superintendent, labor, insurance, & other accessories and services necessary to complete the said project within the unit costs stated within the bid price.
- 2. The work to be done under this contract is as shown and described on the drawings. Each bidder shall make a careful examination of the plans and specifications (the plan shall dictate quantities) and acquaint himself with all conditions before making their proposal. They will be held responsible for errors in their proposal resulting from their failure to make such an examination. All bidders shall visit the site and inform themselves of all conditions.
- 3. The bids shall be based on materials and equipment complying with the drawings and the specifications. The contractor shall be responsible under this contract price, for furnishing and installing materials confirming to the bid items. Under no circumstances may a species 'hybrid' be substituted or size changed without written consent of the landscape architect.
- 4. The contractor shall be responsible for the protection of such existing utilities as water mains, sewer systems, gas mains, electrical conduits, telephone lines and any other utilities and if any damage or destruction may occur to these utilities, they shall be responsible for their repair and/or replacement at their expense.
- 5. The contractor shall make payment for all damages to buildings, structures, trees, shrubs and/or any other property outside the construction area or located within those limits but not designated for removal or reconstructed providing such damage shall result from accident caused by negligence for which the contractor shall be legally liable.
- 6. If additional labor and/or materials is requested or required, the contractor shall submit a price to the owner. If the owner approves the price they shall prepare a change order for approval and signature. The contractor shall not proceed without a written authorization from the owner for the additional work. If the contractor proceeds with the additional work without this authorization he shall forfeit any claim for additional compensation.
- 7. The landscape architect (L.A.) shall reserve the right to inspect the project work at any time deemed necessary to Insure that the specifications and plans and any other contract documents are being followed.
- 8. The L.A. shall have the right to reject any plant on-site based upon condition, size, or incorrect species or hybrid. L.A. must be contacted prior to install, to inspect materials delivered to the site, and to insure that soil amendments, bark mulch, roof ballust, etc. are to the written specifications.
- 9. All seeded areas shall receive a minimum 6" topsoil blanket (by site contractor) w/site preparation, raking and general clean up prior to application. Operations shall include a preemergence type herbicide, 12 -25 -12 granular fertilizer @ 10 lbs./1000 sf., and pelletized limestone @ 25 lbs. /1000 s/f power raked into the top 2" of soil prior to hydro-seeding. Ratios & application rates may change based upon the required soil analysis.
- 10. Contractor is responsible for establishing a thick, weed free lawn. Seed shall be spread @ 4lbs./1000. Lawn germination shall be 95% free of noxious weeds for acceptance. Define differences in seed mixes (if applicable) with irrigation flagging until 2nd mowing. Site review by L.A. is required.

- 11. Review of the installed irrigation system by the designer is required prior to release of final payment.
- 12. Hydroseeding operations shall be a one part process with a paper fiber mulch; a tackifier shall be applied on all slopes greater than 3:1, Excelsor Drainage mat shall be applied to all 2:1 slopes and drainage swales per plan.
- 13. Contractor shall maintain, from acceptance date, the lawn areas through the first mowing. Contractor is not responsible for the first mowing.
- 14. All plant materials shall be installed in accordance with A.L.C.C. Trees and shrubs shall have appropriate soil mixtures, fertilizer and soil retention granules.
- 15. If the soil conditions are extremely sandy, all trees shall have a 6" layer of compacted topsoil (verify with L.A.) placed in the base of the plant pit as a moisture retention layer. The plant pit sidewalls shall be over excavated by an additional 12" beyond the normal outside radius of the hole. A topsoil planting mixture shall be used to backfill as per spec # 22.
- 16. Landscape architect shall have the right to reject and have ground removed any plant material not of proper size or of weak quality, ie. thin, no lower branching, etc. Contractor must submit shipping lists (billing invoices) for verification, prior to installation.
- 17. All plant material shall be guaranteed for a period of one (1) year from date of installation. Any material which dies or does not show a healthy appearance within this time shall be replaced at the contractors expense; with same warranty requirements as the original. Warranty does not cover loss due mechanical damage, le. snow storage. Contractor should protect susceptible species from insect infestation. Use a liquid systemic application on birch, etc.
- 18. Plant beds and saucers vary in dia. (refer to dwg). Trees and shrubs shall receive a 4" (settled) covering of pine/hemlock bark mulch; saucer diameters per drawing & details. Deciduous trees shall have a 6' dia. saucer (typ.), evergreen trees shall have a saucer 2' min. beyond it's outer branches. All edges shall have a 'V' groove.
- 19. All B&B material which are encased in wire baskets shall have the wires cut loose and the top third removed prior to backfill operation.
- 20. If road base is encountered in any plant bed areas, ie. parking islands, it shall be removed and suitable amended soil installed per drawings and specifications.
- 21. Soil planting mixture shall be a 6%-10% organic topsoil, amended with 10% wood ash, 10% manure, & 30% peatmoss or incorporate a dehydrated compost material. If planting in sand, gravel or other well drained soils, a 50% peatmoss to excavated soil. Other soil amendments shall include; Agriform tablets, Hydro-Gel or equal, and Roots growth enhancer to all trees and shrubs listed, per manufacturers specifications. All plant material pits will receive a min. 20% in volume mix of a compost soil amendment. Submittal required. 'Roots' STEP 1 can be substituted for the individual supplements. Install per manufacturer's specs.
- 22. Landscape contractor shall not be responsible for topsoil spreading but shall coordinate with the site contractor adherence to the mound grades, plant bed soil depths and soil type per dwgs & spec. Landscape contractor shall power rake-out for seed.


- 23. Landscape contractor shall provide a soil analysis of the topsoil planting mixture. Analysis to show soil classification (min. sandy loam) and nutrients.
- 24. Contractor shall protect all B&B materials left above grade prior to installation from drying out. All plants shall be stored, covered in mulch, and irrigated until planted. Any plant left on the ground and whose outer ball surface drys out, shall be rejected by the landscape architect. Plants stored in shade and off navement
- 25. Plan dictates, contractor shall alert Landscape Architect if any discrepancies exist between the plan, the material list, and as-built site conditions.
- 26. Installer shall notify landscape architect prior to planting, to review plant locations and bedline configurations. If contractor installs without the placement approval of the L.A., said architect shall have the right to relocate any installed plants at the contractor's expense.
- 27. Installer shall notify landscape architect prior to plant installation to review all materials. Any plants of poor condition, improper size, or species will be
- 28. Upon one year review, contractor shall straighten any trees that have shifted.

  Any weak or bare spots in lawn shall be reseeded.
- 29. All bedlines shall have a deep 'V' groove to define lawn to mulch edge. No 'Beehive" mounding of mulch is allowed, also keep mulch away from base of
- 30. Do not plant materials too close to the edge of bedlines. Refer to drawings for center of plant to bedline. At a minimum no outer branching of a shrub or perennial shall be closer than two feet from the bedlines. If the as-built does not comply contractor shall adjust the plant location or bedline at his expense.
- 31. Seed mixes include: Sandy Soil Lawn Mix by: deercreekseed.com; New England Wetland Plants, Amherst, Ma. refer to planting plan for designations.
- 32. Any items not completed to the specifications will be required at contractors expense prior to final approvals. Contractor is to bid the work according to the specifications and not to what they may do under their standard practices. Special attention will be payed to soils, amendments, guy stakes, bedline & saucer configurations, seed mixtures, etc.
- 33. Certain designated foundation edging is rood ballust (washed rounds, non-crushed, natural) Size of stone is a range of 3/4"-1.5"dia. placed to a depth of 3", upon placement apply a coating of granular Preen (preemergent).
- 34. Any questions concerning this drawing shall be directed to Joseph Hochrein, 85 Frost Lane, Webster, NH 03303, 603-648-2541.

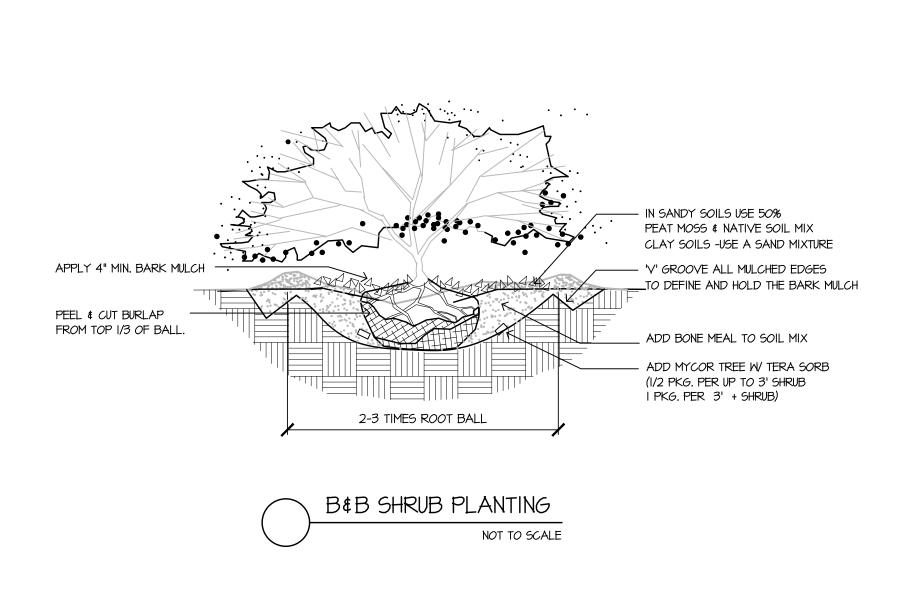

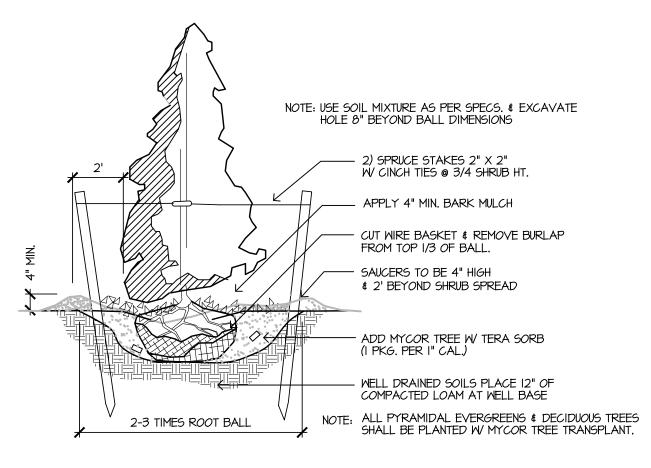



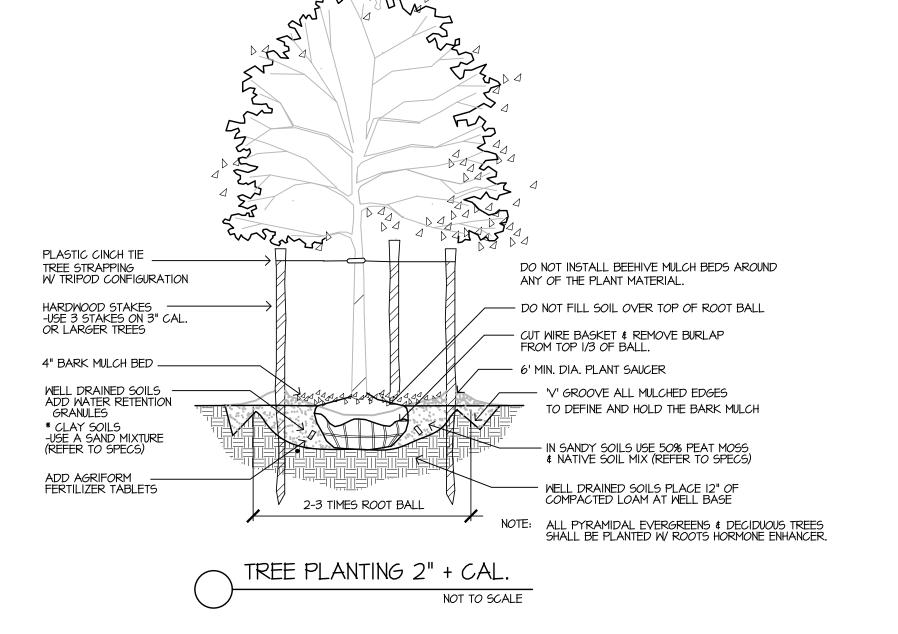



DETAIL SHEET - LANDSCAPE

(MAP 2, LOT 109)

PROPOSED DENTAL OFFICE 108 PONEMAH ROAD AMHERST, NEW HAMPSHIRE

PREPARED FOR/RECORD OWNER:

AZ REALTY, LLC

12 GILBOA LANE NASHUA, NEW HAMPSHIRE 03062

NO SCALE

**APRIL** 2024

PREPARED BY :

JOSEPH HOCHREIN

PHONE (603) 648 - 6500 FAX (603) 648 - 6506

Land Planning - Landscape Architecture

85 Frost Lane - Webster, NH 03303

FIELD BOOK: 1276 DRAWING NAME: 5934—SITE—LS21

DRAWING LOC: J: \5000\5934 \DWG\5934 SITE

5934—SITE 15 OF 16

